


## Austin City Council:

Lee Leffingwell - Mayor Sheryl Cole - Mayor Pro Tem Chris Riley Mike Martinez Kathie Tovo Laura Morrison Bill Spelman

# Austin City Manager:

Marc A. Ott

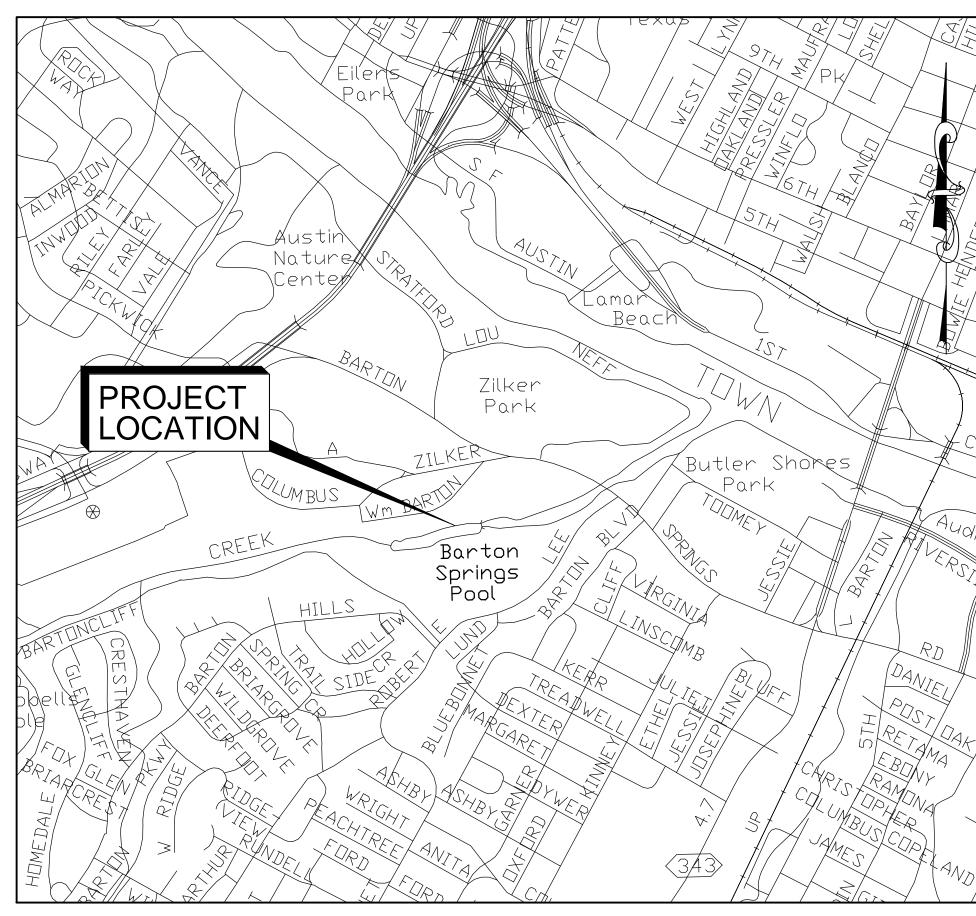

VICINITY MAP

COA GRID: H22 MAPSCO #: 584Y

## Revised (R Add (A) Void (V) Sheet No.'s Sheets in Approval Date Plan Set (Sq.Ft.) (Sq. Ft.)

**Net Change** 

Description

City Of Austin

**Total Site** 

Date Imaged

## NOTES:

- 1. THIS PROJECT IS LOCATED IN THE BARTON CREEK WATERSHED
- 2. THIS PROJECT IS LOCATED IN THE BARTON SPRINGS ZONE

- 5. THIS PROJECT IS SUBJECT TO THE VOID AND WATER FLOW MITIGATION RULE (ECM 1.12.0) AND COA STANDARD SPECIFICATION ITEM 658S, ALL TRENCHING GREATER THAN 5 FT DEEP MUST BE INSPECTED BY A GEOLOGIST (TEXAS P.G. OR A GEOLOGISTS REPRESENTATIVE).
- 6. THE PROJECT SITE IS ZONED PUBLIC-P AND PUBLIC-HISTORIC P-H
- 7. AN AMENDMENT TO THE SAVE OUR SPRINGS ORDINANCE WILL BE REQUIRED TO ALLOW CONSTRUCTION OF THIS
- 8. CALL ONE CALL CENTER (1-800-344-8377) FOR UTILITY LOCATIONS PRIOR TO ANY WORK IN CITY EASEMENTS OR
- 9. NOTIFY THE PUBLIC WORKS DEPARTMENT, IN WRITING, TWENTY FOUR (24) HOURS PRIOR TO STARTING CONSTRUCTION OR CLEARING OPERATIONS.
- 10. RELEASE OF THE APPLICATION DOES NOT CONSTITUTE A VERIFICATION OF ALL DATA, INFORMATION AND CALCULATIONS SUPPLIED BY THE APPLICANT. THE ENGINEER OF RECORD IS SOLELY RESPONSIBLE FOR THE COMPLETENESS, ACCURACY, AND ADEQUACY OF HIS/HER SUBMITTAL, WHETHER OR NOT THE APPLICATION IS REVIEWED FOR CODE COMPLIANCE BY THE CITY ENGINEERS.

Construction Drawings for

# ELIZA SPRING **OUTLET DAYLIGHTING**

BARTON SPRINGS POOL AREA

C.I.P. No. 5282.074

SITE ADDRESS: 2201 Barton Springs Rd

Austin, TX 78746

HDR Project No. 000000000220162

Austin, Texas JANUARY 2014

IT IS NOT TO BE USED FOR CONSTRUCTION OR ANY OTHER PURPOSE.

ISSUED FOR 60% REVIEW JANUARY 24, 2014

## INDEX OF DRAWINGS

No.	General	
1	G1.1	Cover
2	G1.2	General Notes
3	G1.3	Overall Site Plan
	I	
No.	Civil	
4	X1.1	Amphitheater Masonry Demolition Plan
5	X1.2	Amphitheater Masonry Demolition Elevation
		I
No.	Civil	
6	C1.1	ES Control & Tree Protection
		T
7	C2.1	General Project Layout
8	C2.2	Outlet Channel - Plan & Profile
9	C2.3	Typical Channel Sections w/ Slope System Details
10	C2.4	Misc. Channel Details
11	C2.5	Cross Sections
		T
12	C3.1	Storm Drain Line A Drainage Area Map
13	C3.2	Storm Drain Line A Plan & Profile
14	C3.3	Storm Drain Line B Plan & Profile
15	C3.4	Construction Details
No.	Landscape	
16	L 1.1	Landscape Plan



HDR Engineering, Inc. Firm Registration No. 754 4401 West Gate Blvd., Ste 400 Austin,Tx 78745 Ph: (512)912-5100 Fax: (512)912-5158

OWNER:

**City of Austin** 

MANAGING DEPARTMENT CONTACT:

Liza Colucci, Project Sponsor **505 Barton Springs Road** 11th Floor

Austin, TX 78704

(512) 974-2669 Fax: (512) 974-2846

SPONSORING DEPARTMENT CONTACT:

Liza Colucci, Project Sponsor 505 Barton Springs Road

11th Floor

**Austin, TX 78704** (512) 974-2669 Fax: (512) 974-2846

**ENGINEER OF RECORD:** 

Scott M. Muchard P.E., C.F.M. HDR Engineering, Inc. 4401 West Gate Blvd., Ste. 400 Austin, Texas 78745

SHEET 1 OF 16

Phone: 512.912.5100 Fax: 512.912.5158

## Sponsoring Department:

**SUBMITTAL DATE: XXXXXXXXX** 

Watershed Protection Department	Date
Managing Department:	
Watershed Protection Department	 Date
Submitted By:	
HDR Engineering	Date
Reviewed By:	
For Director, Planning and Development Review Department	Date
SP-####	
Site Plan/ Development Permit Number	Date

#### GENERAL CONSTRUCTION NOTES

- 1. ALL RESPONSIBILITY FOR THE ADEQUACY OF THESE PLANS REMAINS WITH THE ENGINEER WHO PREPARED THEM. IN REVIEWING THESE PLANS, THE CITY OF AUSTIN MUST RELY ON THE ADEQUACY OF THE WORK OF THE DESIGN ENGINEER.
- 2. CONTRACTOR SHALL CALL THE ONE CALL CENTER (1-800-344-8377) FOR UTILITY LOCATIONS PRIOR TO ANY WORK IN CITY EASEMENTS OR STREET R.O.W.
- 3. CONTRACTOR SHALL NOTIFY THE CONSTRUCTION INSPECTION DIVISION OF THE CITY'S ONE STOP SHOP (OSS) AT 974-6360 OR 974-7034 AT LEAST 24 HOURS PRIOR TO THE INSTALLATION OF ANY DRAINAGE FACILITY WITHIN A DRAINAGE EASEMENT OR STREET R.O.W. THE METHOD OF PLACEMENT AND COMPACTION OF BACKFILL IN THE CITY'S R.O.W. MUST BE APPROVED PRIOR TO THE START OF BACKFILL OPERATIONS.
- 4. ALL CONSTRUCTION OPERATIONS SHALL BE ACCOMPLISHED IN ACCORDANCE WITH APPLICABLE REGULATIONS OF THE U.S. OCCUPATIONAL SAFETY AND HEALTH ADMINISTRATION. (OSHA STANDARDS MAY BE PURCHASED FROM THE GOVERNMENT PRINTING OFFICE; INFORMATION AND RELATED REFERENCE MATERIALS MAY BE PURCHASED FROM OSHA, 611 EAST 6TH STREET, AUSTIN TEXAS.)
- 5. ALL SITE WORK MUST ALSO COMPLY WITH ENVIRONMENTAL REQUIREMENTS.
- 6. UPON COMPLETION OF THE PROPOSED SITE IMPROVEMENTS AND PRIOR TO THE FOLLOWING, THE ENGINEER SHALL CERTIFY IN WRITING THAT THE PROPOSED DRAINAGE, FILTRATION AND DETENTION FACILITIES WERE CONSTRUCTED IN CONFORMANCE WITH THE APPROVED PLANS.

#### SPECIAL CONSTRUCTION NOTES

- 1. BLASTING WITHIN THE PROJECT AREA WILL NOT BE ALLOWED WITHOUT A SEPARATE BLASTING
- 2. THE CONTRACTOR SHALL FURNISH, INSTALL AND MAINTAIN BARRICADES, WARNING SIGNS, FLASHERS AND OTHER DEVICES OF THE TYPE AND SIZE AS INDICATED IN THE LATEST EDITION OF THE TEXAS MANUAL ON UNIFORM TRAFFIC CONTROL DEVICES, OR AS DIRECTED BY THE ENGINEER.
- 3. THE CONTRACTOR SHALL MAINTAIN AT LEAST ONE DUST-FREE LANE FOR TRAFFIC WITH FLAGMEN DURING CONSTRUCTION ACTIVITIES AND TWO LANES AT ALL OTHER TIMES. ACCESS TO CONTIGUOUS PRIVATE PROPERTIES SHALL BE MAINTAINED AT ALL TIMES.
- 4. ALL STRUCTURAL CONCRETE SHALL BE CLASS "A" (5 SACK, 25-8-36100 PSI @ 28 DAYS) AND ALL REINFORCING STEEL SHALL BE GRADE SIXTY, UNLESS OTHERWISE NOTED.
- 5. THE CONTRACTOR SHALL NOT DISPOSE OF SURPLUS EXCAVATED MATERIAL FROM THE SITE WITHOUT NOTIFYING THE ENVIRONMENTAL INSPECTOR, AT 974-2278, 48 HOURS PRIOR TO THE REMOVAL. THIS NOTIFICATION SHALL INCLUDE THE DISPOSAL LOCATION AND A COPY OF THE PERMIT ISSUED TO RECEIVE THE MATERIAL, IF APPLICABLE.
- 6. UTILITIES SHOWN REFLECT THE BEST INFORMATION AVAILABLE AT THE TIME THE PROJECT WAS SURVEYED. UTILITY RELOCATION WORK HAS BEEN OR WILL BE ACCOMPLISHED TO CLEAR THE WORK SPACE. THESE RELOCATIONS ARE NOT REFLECTED ON THESE DRAWINGS. FOR EXACT LOCATIONS CALL 472-2822, 48 HOURS PRIOR TO BEGINNING EXCAVATION.
- 7. ALL STORM SEWER PIPE SHALL BE RCP, CLASS III, WITH CLASS B BEDDING, UNLESS OTHERWISE
- 8. SIGNS IN THE WAY OF CONSTRUCTION SHALL BE REMOVED AND RELOCATED AS SOON AS POSSIBLE. ALL TRAFFIC CONTROL SIGNS, INCLUDING STOP AND STREET-NAME SIGNS, SHALL NOT BE REMOVED OR RELOCATED WITHOUT THE APPROVAL OF THE PROJECT INSPECTOR AND THE TRANSPORTATION ENGINEERING DIVISION OF THE DEPARTMENT OF TRANSPORTATION. THIS WORK SHALL BE SUBSIDIARY TO OTHER BID ITEMS.
- 9. ALL SITE WORK MUST COMPLY WITH THE ENVIRONMENTAL REQUIREMENTS.
- 10. THE CONTRACTOR SHALL ERECT AND MAINTAIN A FILTER FABRIC FENCE AT LOCATIONS SHOWN ON THE PLANS AND ANY OTHER LOCATIONS DESIGNATED BY THE ENGINEER. PAYMENT WILL BE MADE UNDER ITEM NO. 620 FILTER FABRIC FENCE.
- 11. ANY UTILITY METERS IN THE WAY OF THE CONSTRUCTION WILL BE RELOCATED OUTSIDE OF THE PROPOSED CONSTRUCTION AREA BY THE UTILITY OWNER UNLESS SUCH WORK AFFECTING THOSE METERS IS INCLUDED IN THE CONTRACT.
- 12. ANY AREAS TO RECEIVE TRANSITION PAVEMENT SHALL BE CONSTRUCTED WITH THE SAME TYPICAL SECTION AS THE ADJACENT NEW CONSTRUCTION.
- 13. ANY EXISTING SIDEWALKS, CURBS OR DRIVEWAYS DISTURBED BY THE CONSTRUCTION SHALL BE REMOVED AND RESTORED WITH SURFACE MATERIALS EQUAL TO OR BETTER THAN THE ORIGINAL.
- 14. THE REMOVAL OF EXISTING DRIVEWAY PIPE CULVERTS, RIPRAP AND HEADWALLS IN THE WAY OF CONSTRUCTION WILL NOT BE PAID FOR DIRECTLY, BUT SHALL BE SUBSIDIARY TO OTHER BID
- 15. THE RATE OF HYDRATED LIME APPLICATION USED TO DETERMINE THE QUANTITIES FOR THIS PROJECT IS BY WEIGHT.
- 16. IN AREAS WHERE EXISTING CURBS AND GUTTERS ARE TO REMAIN, THE OLD PAVING AND BASE MUST BE REMOVED AND THE NEW BASE AND PAVING PLACED AND COMPACTED SO AS NOT TO DISTURB EXISTING CURBS AND GUTTERS.

#### **DEVELOPER INFORMATION**

PHONE#:

OWNER: LIZA COLUCCI, CITY OF AUSTIN WATERSHED PROTECTION DEPARTMENT ADDRESS: 505 BARTON SPRINGS ROAD, AUSTIN, TX 78701 PHONE #: 512-974-2669 OWNER'S REPRESENTATIVE RESPONSIBLE FOR PLAN ALTERATIONS: SCOTT M. MUCHARD, P.E., HDR ENGINEERING, INC. PHONE#: 512-912-5100 PERSON OR FIRM RESPONSIBLE FOR EROSION/SEDIMENTATION CONTROL MAINTENANCE: PHONE#:

PERSON OR FIRM RESPONSIBLE FOR TREE/NATURAL AREA PROTECTION MAINTENANCE:

#### AMERICANS WITH DISABILITIES ACT

THE CITY OF AUSTIN HAS REVIEWED THIS PLAN FOR COMPLIANCE WITH CITY DEVELOPMENT REGULATIONS ONLY. THE APPLICANT, PROPERTY OWNER, AND OCCUPANT OF THE PREMISES ARE RESPONSIBLE FOR DETERMINING WHETHER THE PLAN COMPLIES WITH ALL OTHER LAWS, REGULATIONS, AND RESTRICTIONS WHICH MAY BE APPLICABLE TO THE PROPERTY AND ITS USE.

				PROJECT MANAGER	S. MUCHARD
ברא				DESIGNED BY	E. STEWART
HOR				DRAWN BY	C. AMARAL
IDR Engineering, Inc. Firm Registration No. 754					
401 WEST GATE BLVD., SUITE 400					
AUSTIN, TX 78745 PHONE# (512) 912-5100				CHECKED BY	C. PARKER
FAX# (512) 912-5158	А	1/24/2014	60% DRAFT FOR REVIEW	DATE	JANUARY 2014
	ISSUE	DATE	DESCRIPTION	PROJECT NUMBER	220162

THIS DOCUMENT IS RELEASED FOR THE PURPOSE OF REVIEW UNDER THE AUTHORITY OF SCOTT M. MUCHARD TEXAS P.E. NO.89409 <u> DATE: JANUARY 24, 2014</u> IT IS NOT TO BE USED FOR CONSTRUCTION OR ANY OTHER PURPOSE. 60% DRAFT



## **ELIZA SPRING OUTLET DAYLIGHTING**

**Austin, Texas** 


## **GENERAL NOTES**




FILENAME | G1.2.DWG

SCALE NONE

SHEET G1.2

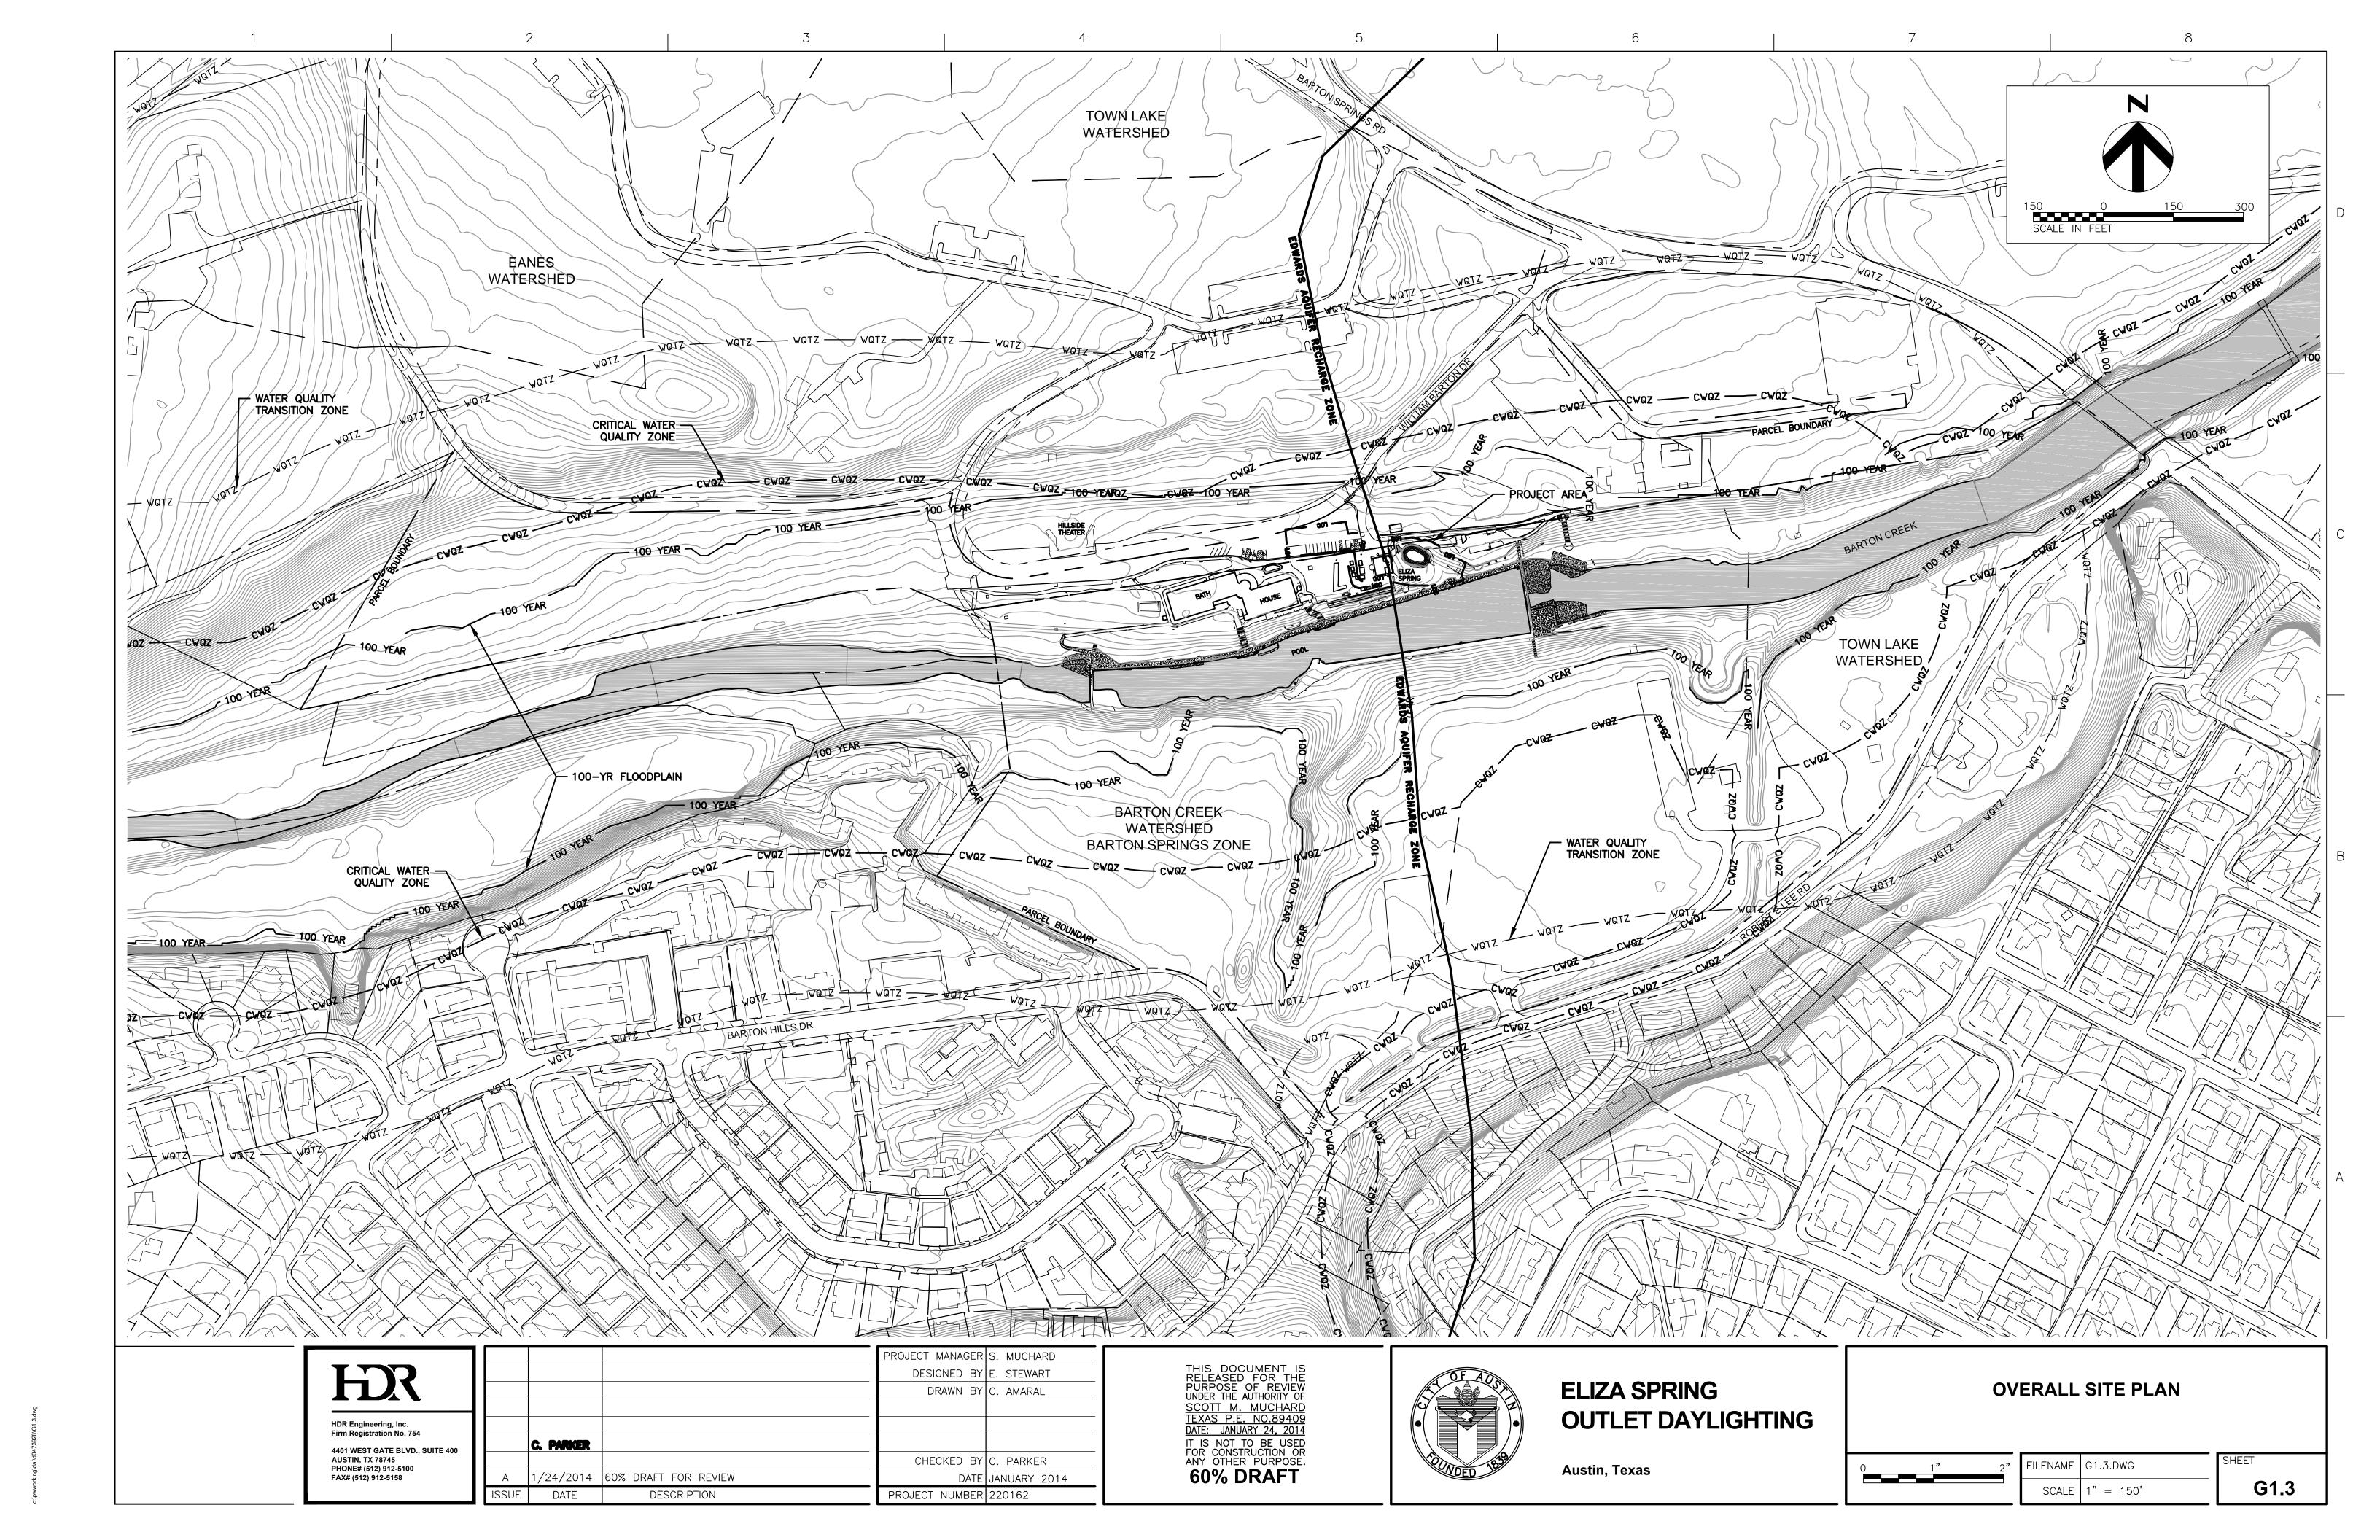

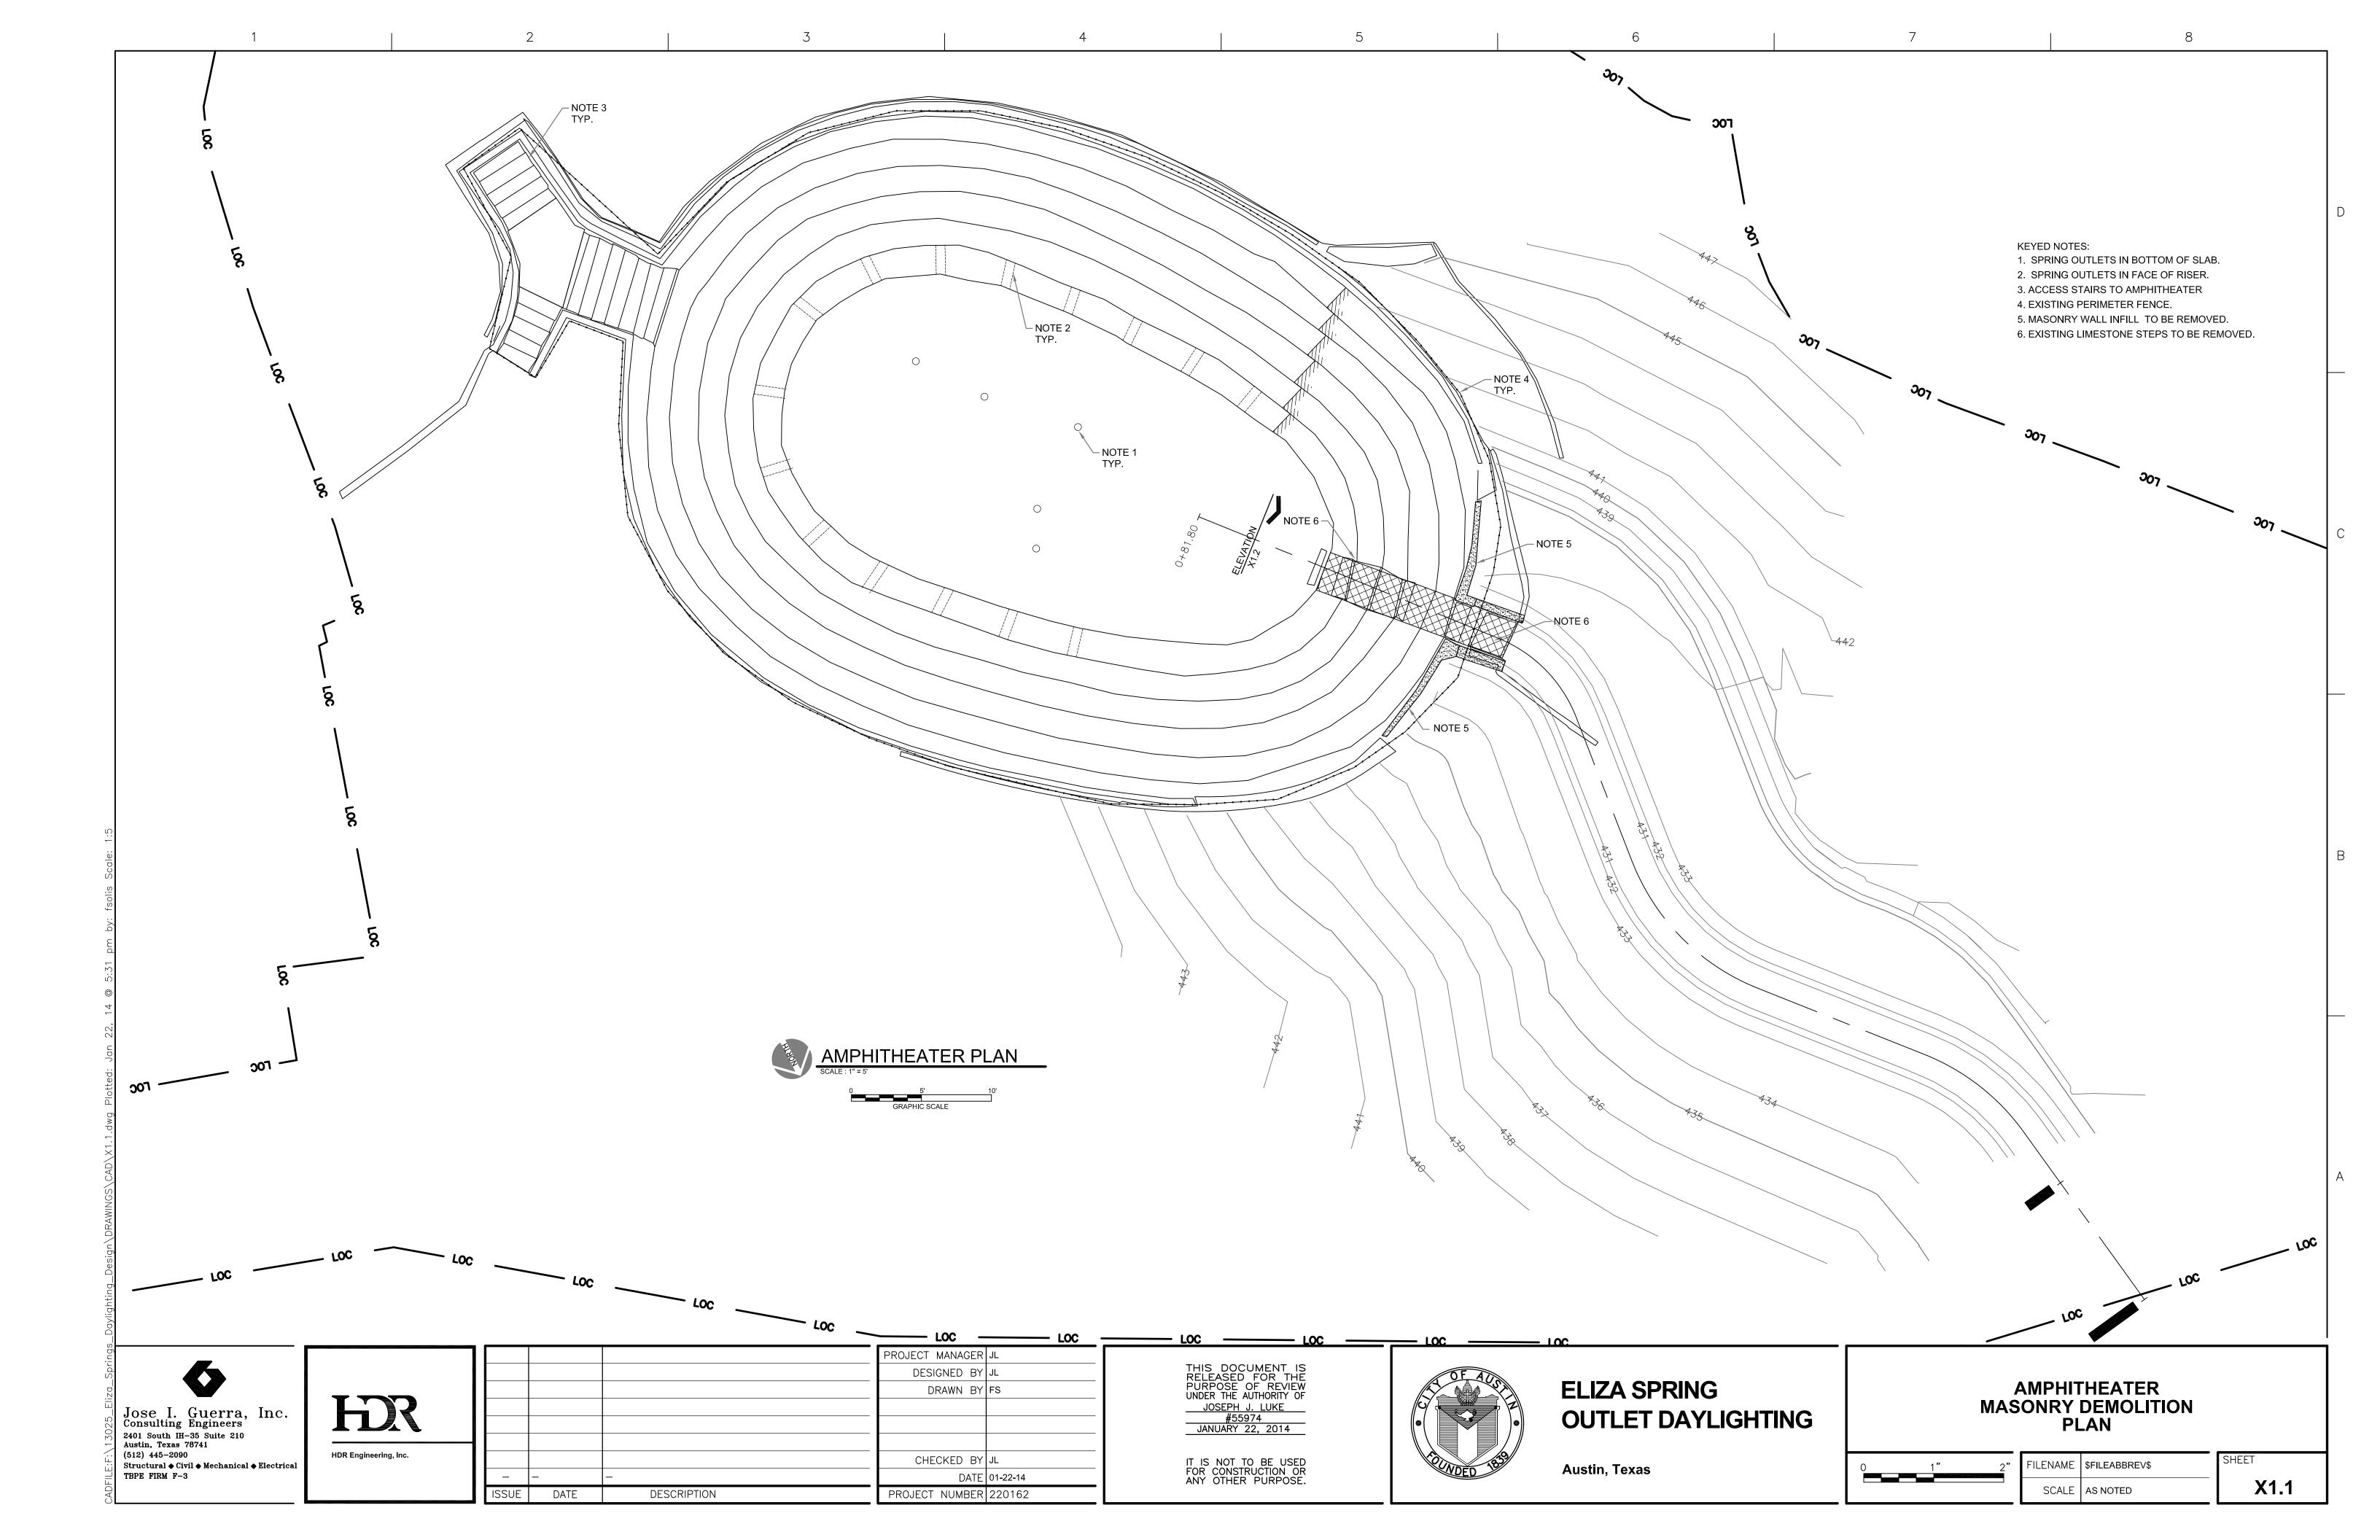

- NOTE 1

ELEVATION - MASONRY INFILL TO BE REMOVED
NO SCALE

KEYED NOTES:

- 1. GRATING AND OUTLET PIPE TO BE REMOVED.
- 2. EXISTING CONCRETE AMPHITHEATER SEATING STEPS TO REMAIN.
- 3. EXISTING STEEL GATE TO BE REMOVED.
- 4. EXISTING LIMESTONE MASONRY INFILL TO BE REMOVED.
- 5. EXISTING LIMESTONE MASONRY STEPS TO BE REMOVED.

### SHEET NOTES:

1. ALL DIMENSIONS SHOWN ARE ENGINEERS ESTIMATES CONTRACTOR TO VERIFY ALL EXISTING CONDITIONS AND DIMENSIONS.

В

\_


X1.2


**(** 

Jose I. Guerra, Inc. Consulting Engineers
2401 South IH-35 Suite 210
Austin, Texas 78741
(512) 445-2090
Structural • Civil • Mechanical • Electrical
TBPE FIRM F-3



			PROJECT MANAGER	JL
			DESIGNED BY	JL
			DRAWN BY	FS
			CHECKED BY	JL
_	_	_	DATE	01-22-14
ISSUE	DATE	DESCRIPTION	PROJECT NUMBER	220162

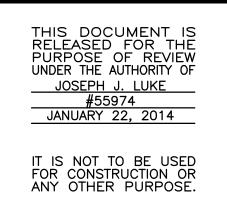


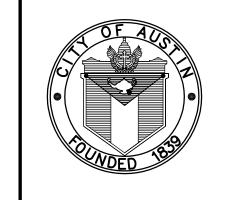


## ELIZA SPRING OUTLET DAYLIGHTING

Austin, Texas


# AMPHITHEATER MASONRY DEMOLITION ELEVATION

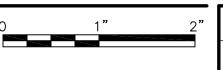



,,	FILENAME	\$FILEABBREV\$	SH
	SCALE	AS NOTED	

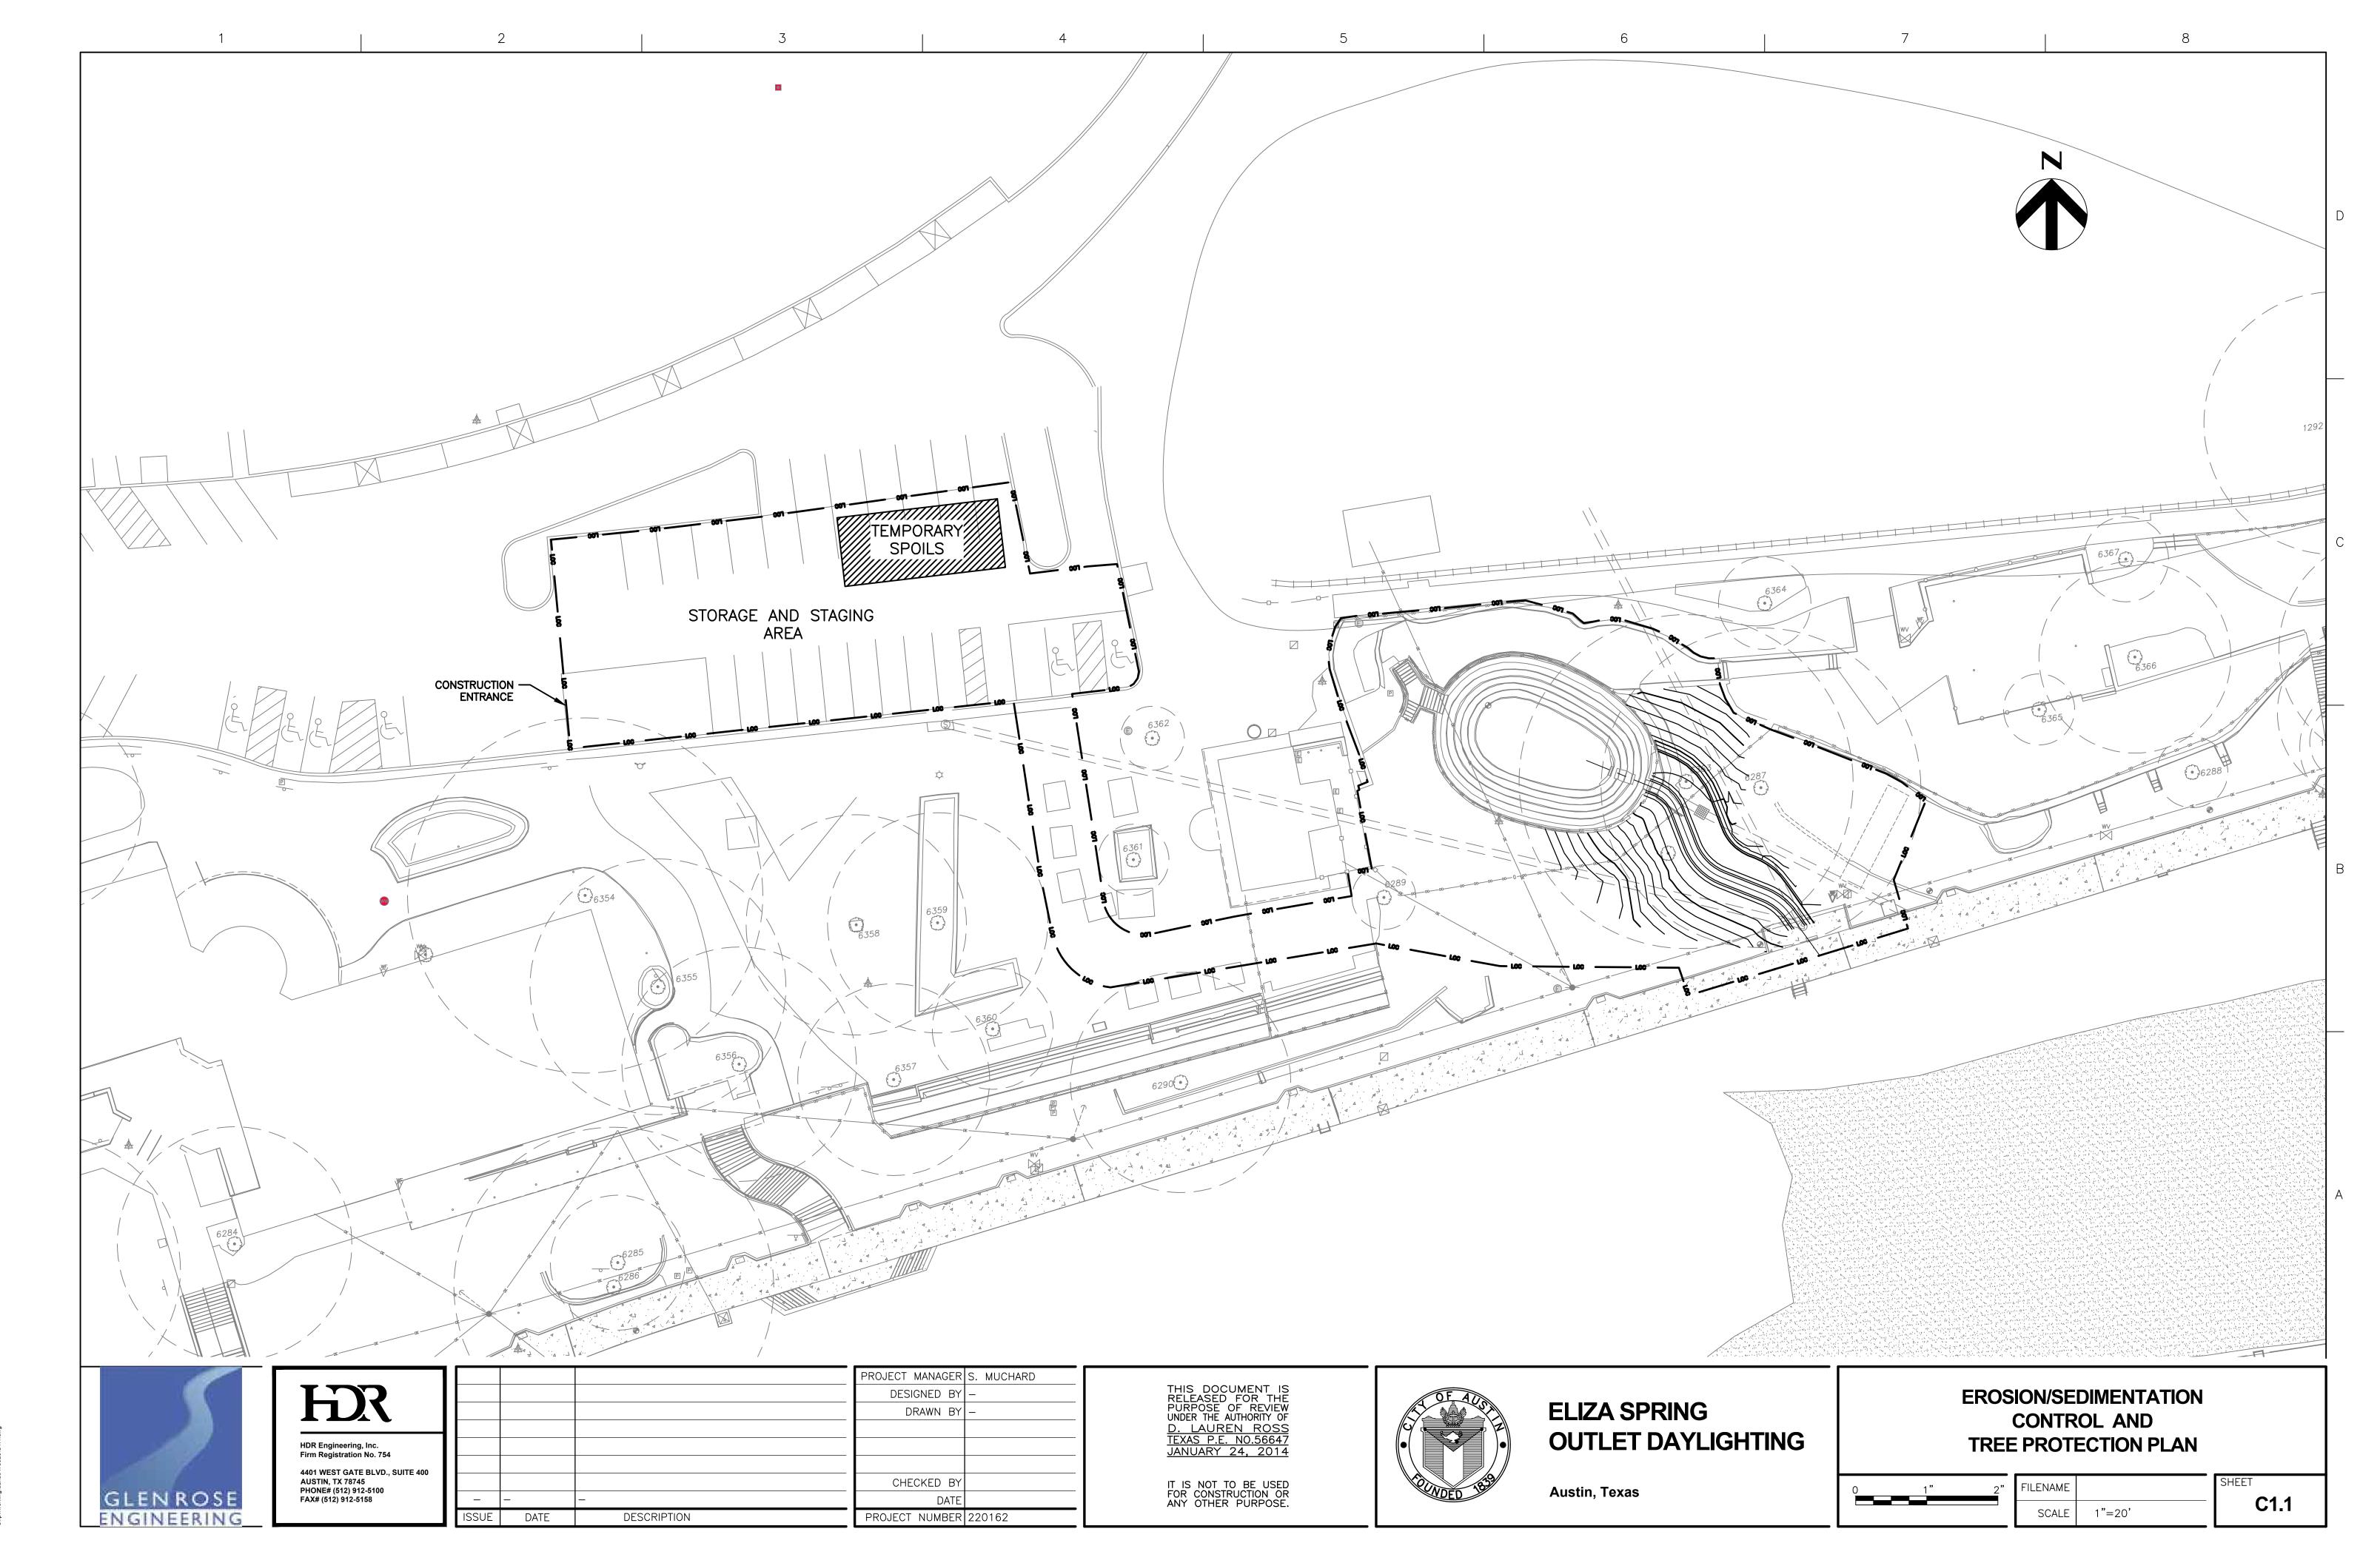

C:\pwworking\dal\d0473928\C1.1.c

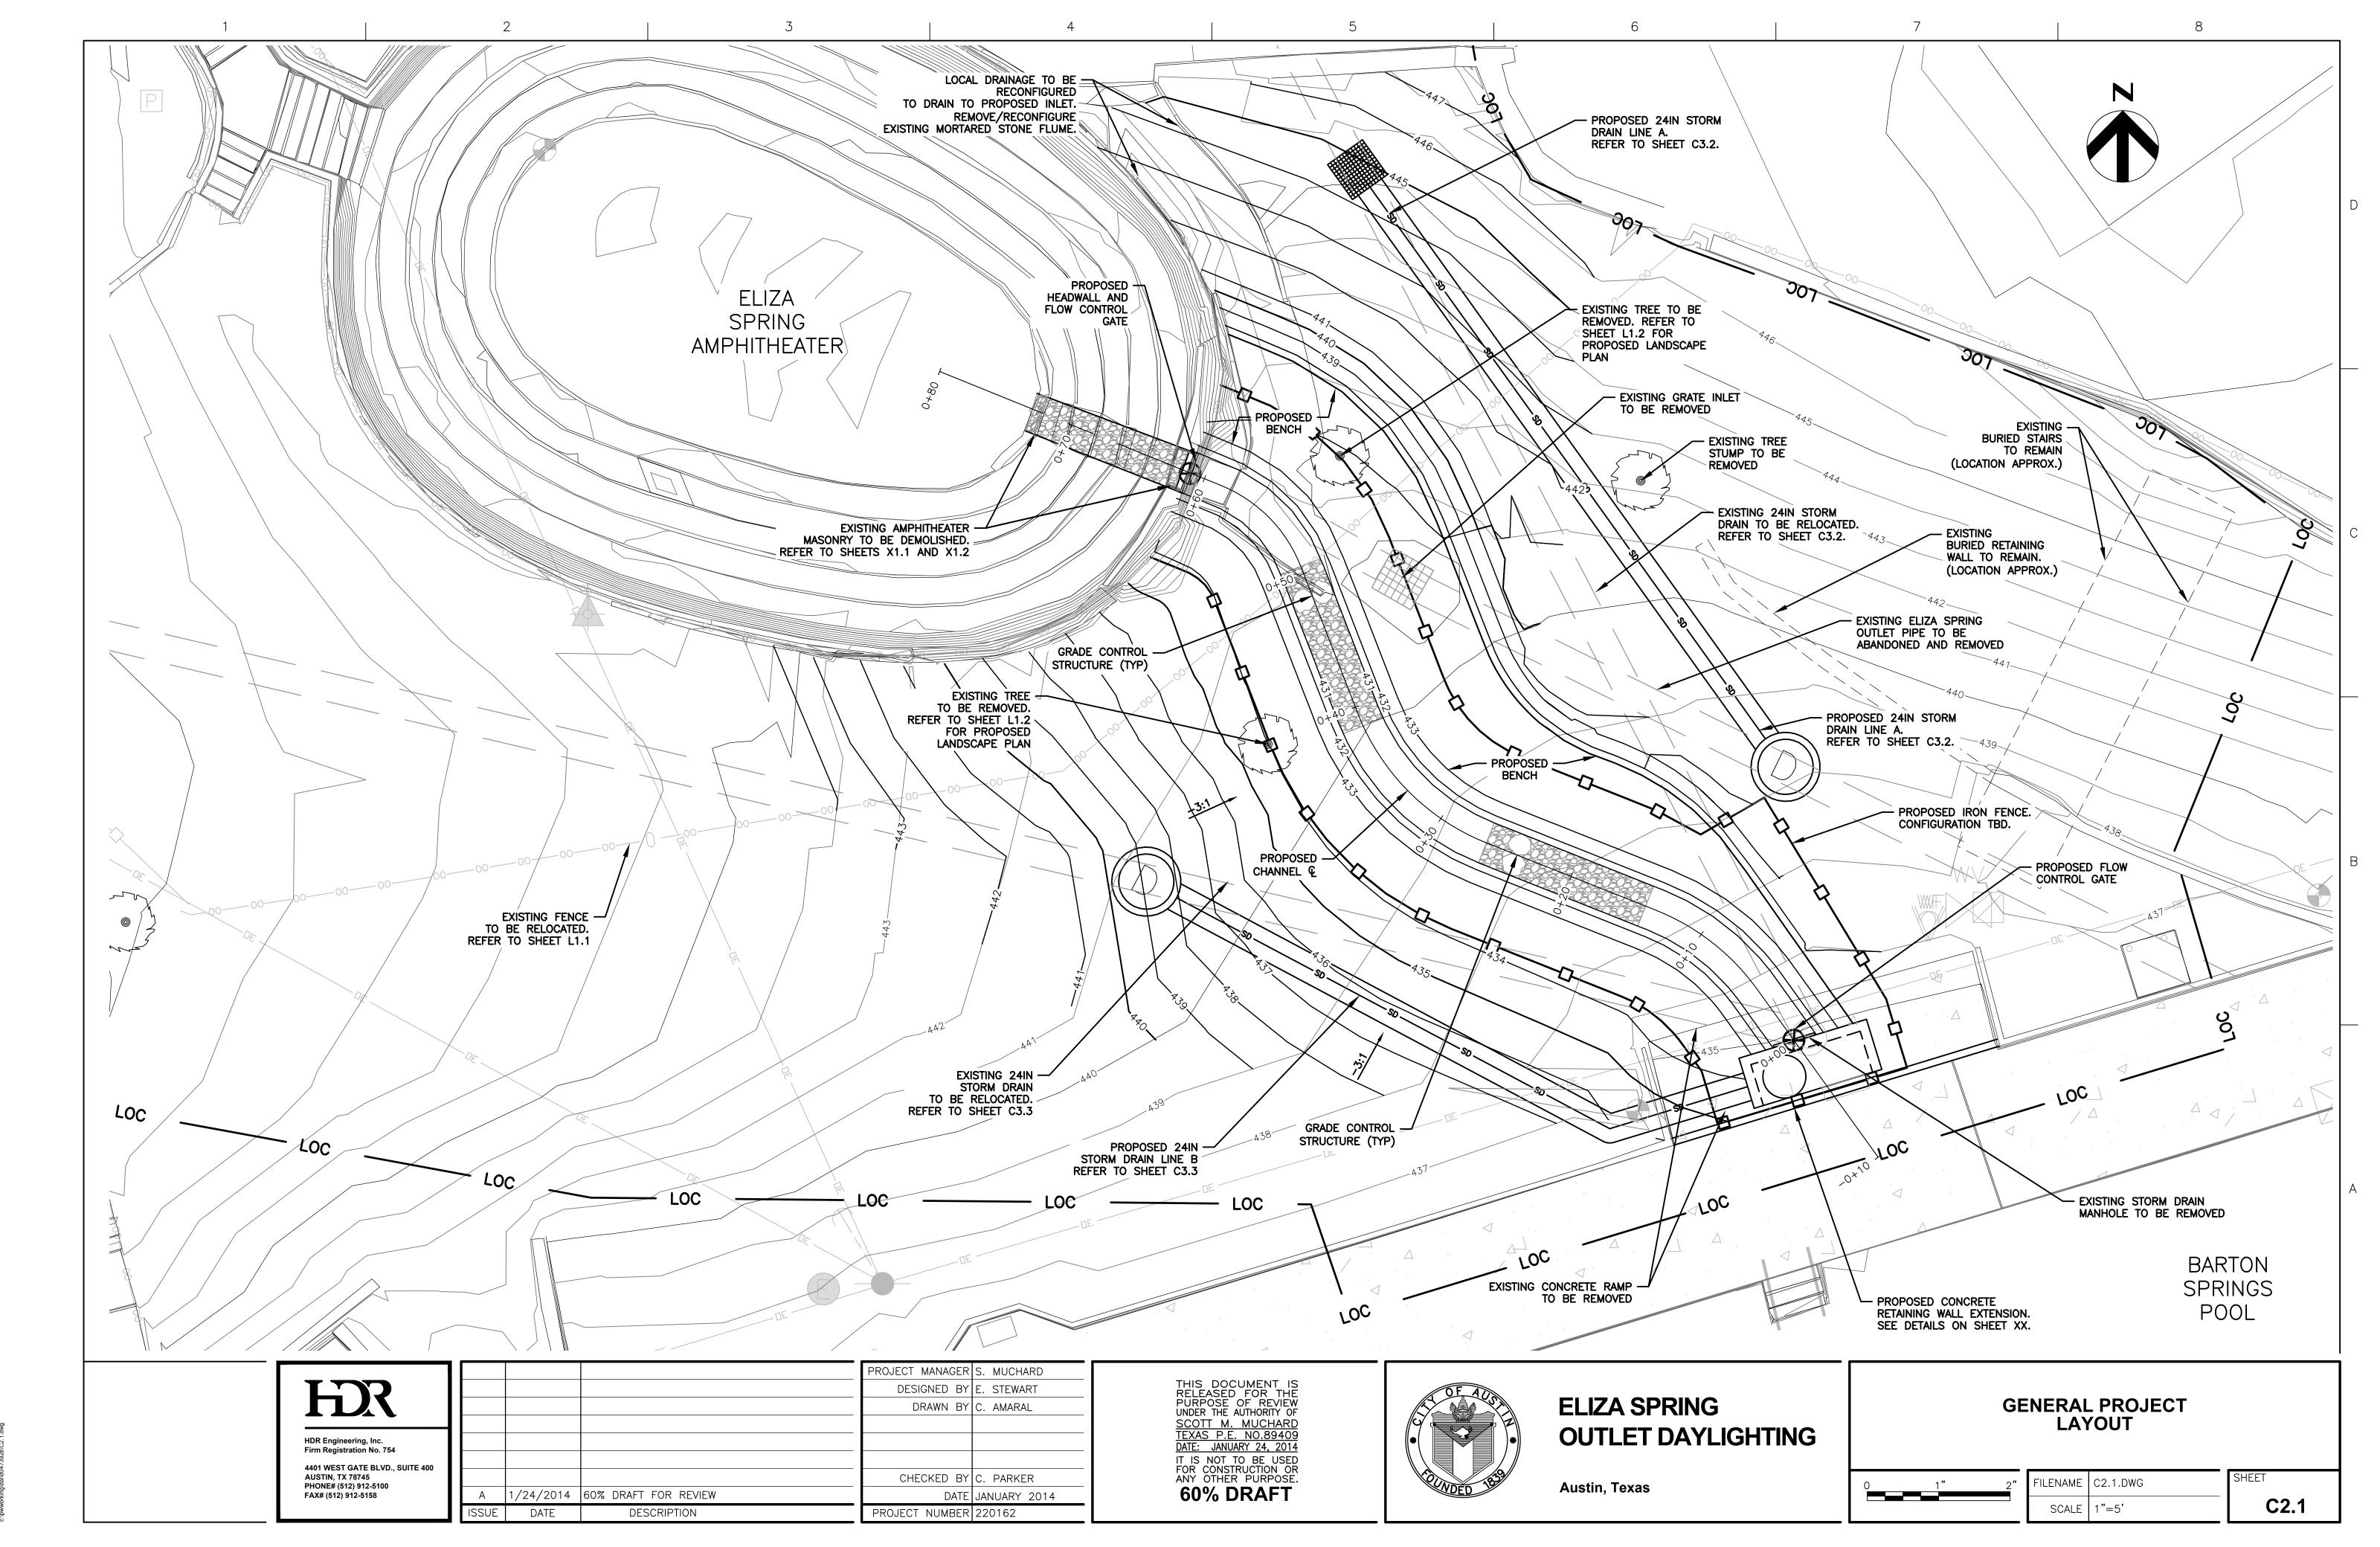

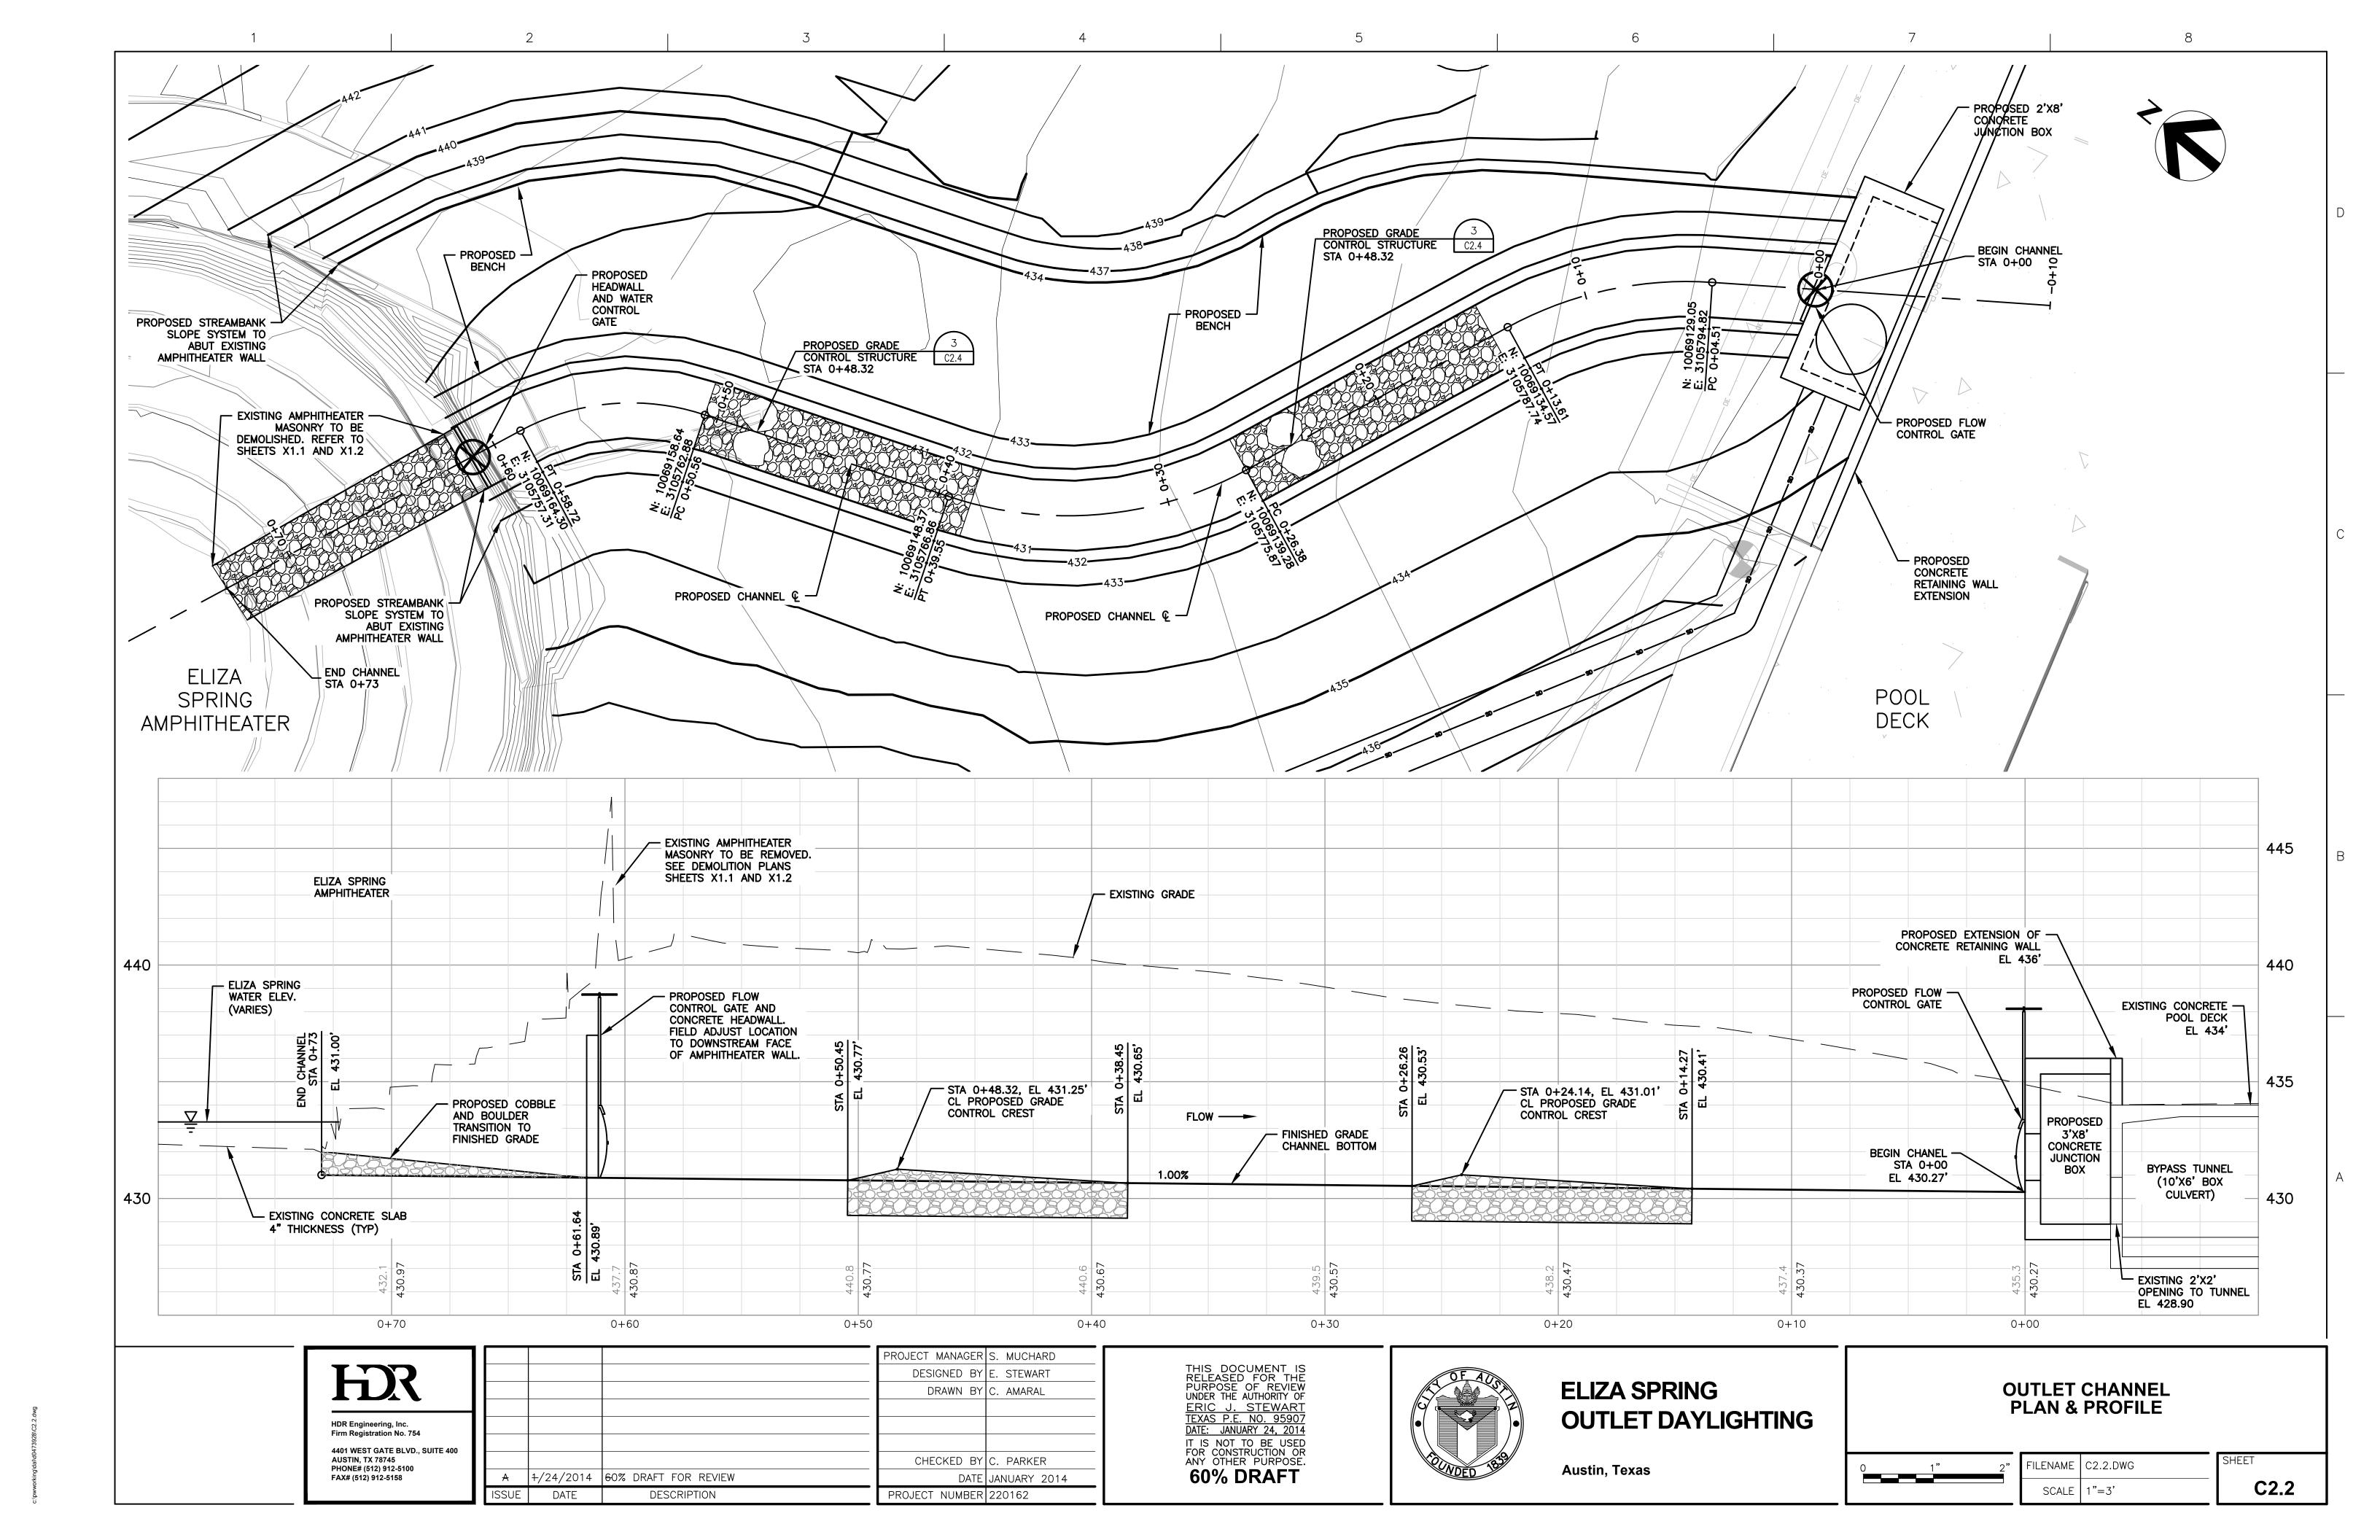

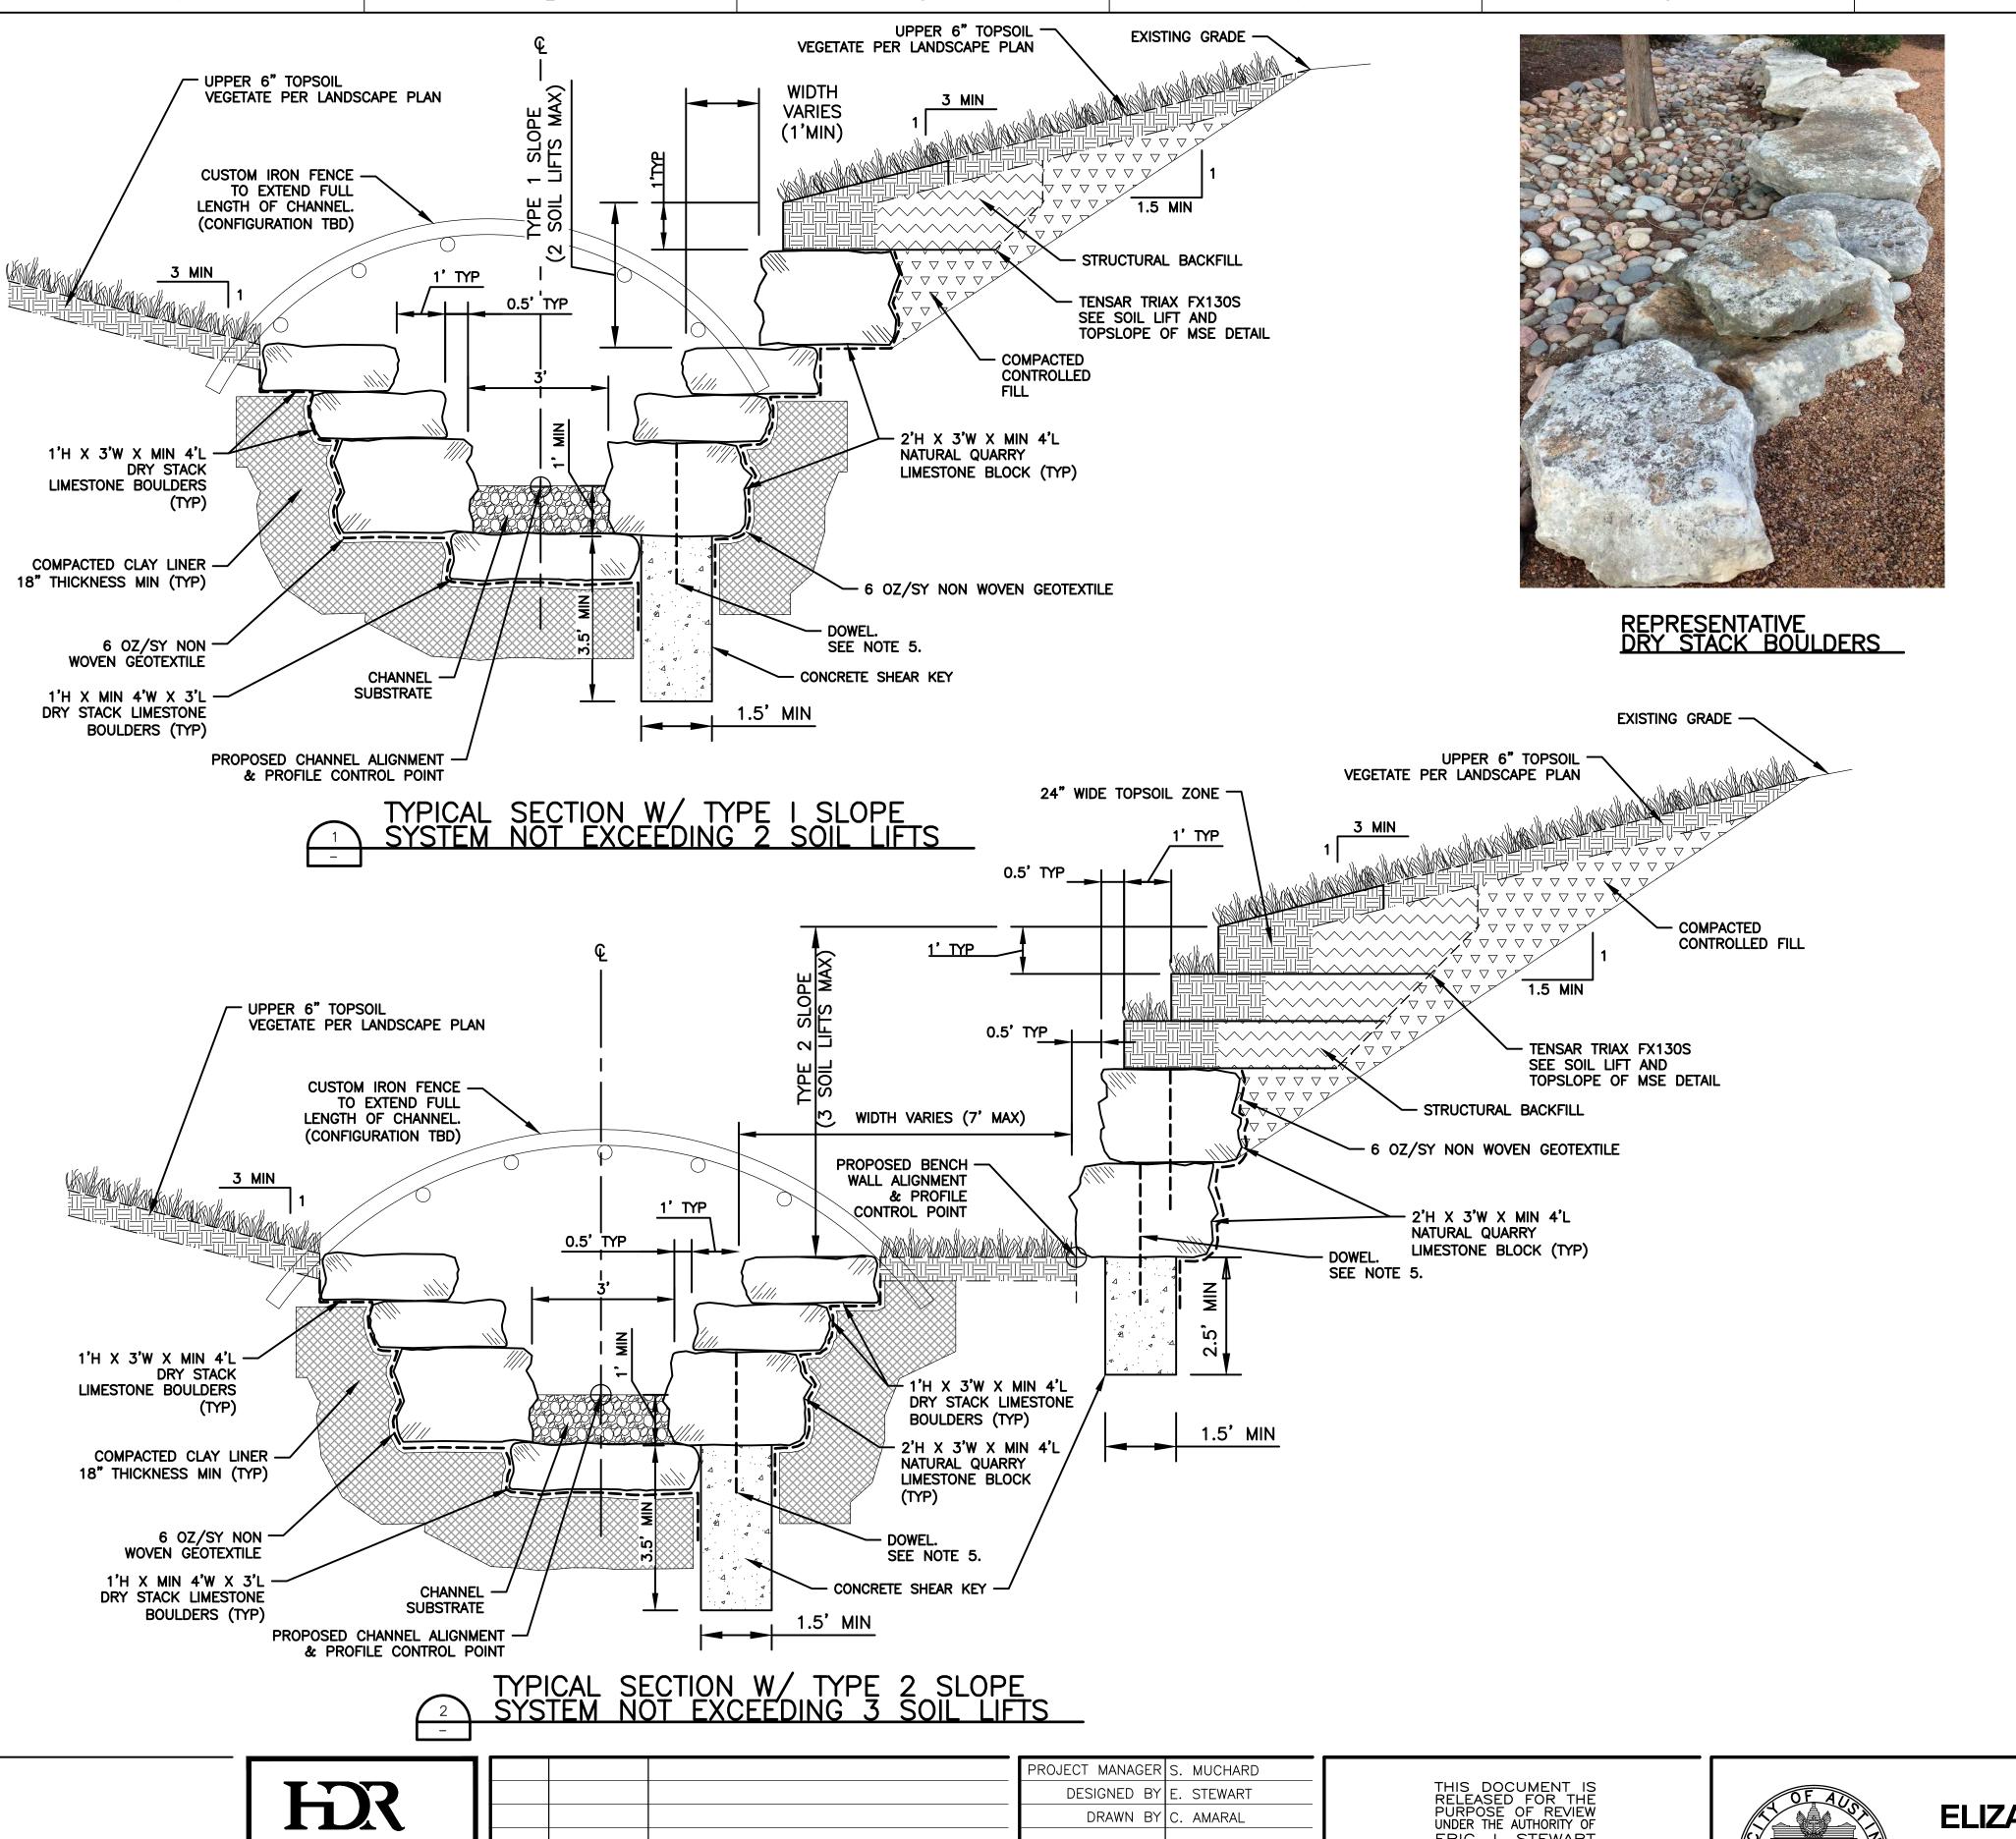

CHECKED BY C. PARKER

PROJECT NUMBER 220162

DATE JANUARY 2014

**CONSTRUCTION NOTES:** 

1. CONTRACTOR IS RESPONSIBLE FOR TEMPORARY STABILITY RELATIVE TO EXCAVATED GEOMETRY AND EROSION CONTROL OF DISTURBED SOIL DUE TO CONSTRUCTION ACTIVITIES.

2. MAJOR EXCAVATION SHALL PRECEDE MSE AND BANK STABILIZATION AND SHALL BE PERFORMED IN ACCORDANCE WITH COA STANDARD SPECIFICATION ITEMS NO. 120S, NO. 132S. EXCAVATION FOR SLOPE SYSTEM CONSTRUCTION SHALL CONSIST OF FINAL SHAPING AND GRADING FOR CONSTRUCTION TO THE DEPTHS, LINES AND GRADES SHOWN ON THE CONSTRUCTION DRAWINGS. CONTRACTOR SHALL BE CAREFUL NOT TO DISTURB SUBGRADE BEYOND THE LINES SHOWN. WHERE AREAS ARE EXCAVATED BELOW THE ALLOWABLE MINUS TOLERANCE LIMIT, THEY SHALL BE BROUGHT TO GRADE BY FILL WITH EARTH SIMILAR TO THE ADJACENT MATERIAL AND COMPACTED TO A DENSITY EQUAL TO THE ADJACENT IN PLACE MATERIAL. THE PREPARED BASE SHALL BE APPROVED BY THE OWNER.

3. THE BASE OF THE SLOPE SHALL BE EXCAVATED AS REQUIRED FOR PLACEMENT OF THE FOOTING ELEMENTS AND/OR BLOCKS. PREPARED SUBGRADE SHALL BE FIRM AND UNYIELDING AND EXHIBIT A RELATIVELY SMOOTH SURFACE CONDITION, FREE FROM OBSTRUCTION, DEBRIS, DEPRESSIONS, EROSION FEATURES, OR VEGETATION. REMOVE ANY IRREGULARITIES SO AS TO ENSURE CONTINUOUS, INTIMATE CONTACT OF THE GEOTEXTILE, BLOCK, AND/OR CONCRETE.

4. CONSTRUCT ALL COMPONENTS OF THE STREAM CHANNEL AND BANK STABILIZATION TO THE LINES AND GRADES SHOWN ON THE DRAWINGS. TOLERANCE IN THE HORIZONTAL PLANE SHALL BE  $\pm 1/2$  0.3 FT. FINAL ELEVATIONS SHALL BE +/- 0.1 FT OF THOSE SHOWN ON THE DRAWINGS. PLACED MATERIAL NOT MEETING THESE LIMITS SHALL BE REMOVED OR REWORKED AS DIRECTED BY THE OWNER.

5. DOWELS MAY BE REQUIRED IN ACCORDANCE WITH THE PLANS AND DETAILS. FOR EACH LIMESTONE BLOCK THAT REQUIRES DOWELING, A 1.5 INCH DIAMETER HOLE SHALL BE DRILLED IN THE LAYOUT SHOWN ON THE DRAWINGS. NO ROCK HAMMERING WILL BE ALLOWED. DOWELS SHALL BE ANCHORED WITH EPOXY ADHESIVE (HILTI HIT-RE-500, OR EQUAL) IN ACCORDANCE WITH THE MANUFACTURER'S INSTALLATION GUIDELINES.

#### DRY STACK LIMESTONE BOULDERS:

6. ROCK TYPE - THE LIMESTONE BOULDERS FOR USE IN THE PROPOSED SLOPE SYSTEMS SHALL BE NATIVE FROM THE EDWARDS FORMATION AND PRE-APPROVED BY THE ENGINEER PRIOR TO CONSTRUCTION. BLOCKS SHOULD BE IRREGULAR IN SHAPE ON ALL EDGES TO PROVIDE A NATURAL AESTHETIC. THE SURFACES AND EDGES TO BE VISIBLE AFTER PLACEMENT WILL BE NATURALLY ROUNDED FROM EXPOSURE AND SOLUTION AT THE ROCK SOURCE. NO EDGES OF THE BLOCKS SHALL BE SAW CUT. BOULDERS SHALL CONSIST OF SOLID ROCK WITHOUT EXCESSIVE FRACTURES, SPALLS, OR WEAK LAYERS.

7. SIZE OF BOULDER - LIMESTONE BOULDERS SHALL BE A 12 INCHES TALL BY 36 INCHES (MIN) WIDE BY 48 INCHES (MIN) LONG UNLESS OTHERWISE SHOWN ON THE PLANS. BLOCKS SHALL BE RELATIVELY UNIFORM IN HEIGHT (MINIMUM DIMENSION) AND WITHIN 20% OF THE DIMENSIONS SPECIFIED. THE LENGTH DIMENSION MAY VARY, BUT SHOULD BE GREATER THAN OR EQUAL TO THREE TIMES THE HEIGHT DIMENSION. THE TOP AND BOTTOM OF THE UNITS SHALL BE APPROXIMATELY PARALLEL SO THAT THEY ARE STACKABLE.

BOULDER INSTALLATION - BOULDERS SHALL BE SELECTED SO THAT ADJACENT BOULDERS FIT TIGHTLY TOGETHER AT THEIR ABUTTING VERTICAL FACE. ALL EDGES OF THE BOULDERS THAT ARE EXPOSED ON THE FRONT TOP AND SIDES WILL BE NATURALLY ROUNDED EDGES. ALL BOULDER COURSES SHALL BE LEVEL. A 6 OZ/SY NON-WOVEN GEOTEXTILE SHALL BE PLACED AT THE BACK FACE OF ALL BOULDER SOIL INTERFACES.

## FILL MATERIALS:

- 9. STRUCTURAL BACKFILL STRUCTURAL BACKFILL SHALL BE ON-SITE SOILS OR IMPORTED SOILS FREE FROM ROOTS, ORGANIC MATTER, DEBRIS, ROCKS LARGER THAN 2 INCHES, FREE WATER, AND OTHER MATERIALS DELETERIOUS TO COMPACTION. THE MATERIAL FROM ALL SOURCES SHALL CLASSIFY UNDER THE UNIFIED SOIL CLASSIFICATION SYSTEM (USCS) AS EITHER SP (POORLY GRADED SAND), SW (WELL GRADED SAND), SC (CLAYEY SAND), GP (POORLY GRADED GRAVEL), GW (WELL GRADED GRAVEL), SM (SILTY SAND), OR CL (LEAN CLAY). IN ALL CASES AND SOURCES, THE PLASTIC INDEX (PI), AS DEFINED IN ACCORDANCE WITH ASTM D4318, SHALL BE 25 OR LESS. FOR NON-PLASTIC SOILS (E.G. SILTY SAND) THE PERCENT PASSING THE NO. 200 SIEVE SHALL BE LESS THAN 25 PERCENT PER ASTM
- 10. COMPACTED CONTROLLED FILL COMPACTED CONTROLLED FILL SHALL BE ON-SITE SOILS OR IMPORTED SOILS IN CONFORMANCE WITH COA STANDARD SPECIFICATION 132S EMBANKMENT.
- 11. CONTROLLED LOW STRENGTH MATERIAL (CLSM) SHALL CONFORM TO COA STANDARD SPECIFICATION 402S CONTROLLED LOW STRENGTH MATERIAL
- 12. TOPSOIL SELECT TOPSOIL IN THE FIRST 24-INCHES HORIZONTALLY FROM THE FACE OF THE MSE SYSTEM AND THE UPPER 6" OF EMBANKMENT SHALL CONFORM TO SALVAGING AND PLACING TOPSOIL REQUIREMENTS IN THE LANDSCAPE PLAN.
- 13. CHANNEL SUBSTRATE SUBSTRATE SHALL BE PRESELECTED BY COA WATERSHED STAFF AND SHALL CONSIST OF GRAVELS, COBBLES, AND BOULDERS.
- 14. COMPACTED CLAY LINER TBD

## **MISCELLANEOUS MATERIALS:**

- 15. DOWEL REINFORCING STEEL SHALL BE #8 BARS AND SHALL CONFORM TO COA STANDARD
- SPECIFICATION 406S REINFORCING STEEL 16. TRACER TAPE SHALL BE A MINIMUM 5.0 MIL OVERALL THICKNESS, DOUBLE-LAMINATED, PERMANENTLY BOLD, BLACK- LETTERED UNDERGROUND DETECTABLE TAPE AS MANUFACTURED BY PRO-LINE SAFETY PRODUCTS CO., UNITED SAFETY AUTHORITY OR EQUAL.

17. EPOXY ADHESIVE SHALL BE HILTI HIT-RE-500, OR APPROVED EQUAL.

18. GEOTEXTILE FOR USE ALONG CUT BANKS, FOOTING ELEMENTS, AND ENCAPSULATING THE GRAVEL BACKFILL SHALL BE 6 OZ/SY NON-WOVEN GEOTEXTILE PER CITY OF AUSTIN SPECIFICATION 620S -FILTER FABRIC. GEOTEXTILÉS SHALL POSSESS THE FOLLOWING MINIMUM PROPERTIES: FABRIC WEIGHT: 6 OZ/SY: GRAB TENSILE STRENGTH (ASTM D4632): 150 LBS; WATER FLOW RATE (ASTM D4491): 110 GPM/SF.

> TYPICAL CHANNEL SECTIONS W/ SLOPE SYSTEM **DETAILS**

TLENAME | C2.3.DWG SCALE | 1"=2'

SHEET C2.3

HDR Engineering, Inc. Firm Registration No. 754

**AUSTIN, TX 78745** 

PHONE# (512) 912-5100

FAX# (512) 912-5158

4401 WEST GATE BLVD., SUITE 400

1-/24/2014 60% DRAFT FOR REVIEW


**DESCRIPTION** 


DATE

ERIC J. STEWART TEXAS P.E. NO. 95907 DATE: JANUARY 24, 2014 T IS NOT TO BE USED FOR CONSTRUCTION OF ANY OTHER PURPOSE 60% DRAFT


**ELIZA SPRING OUTLET DAYLIGHTING** 

**Austin, Texas** 

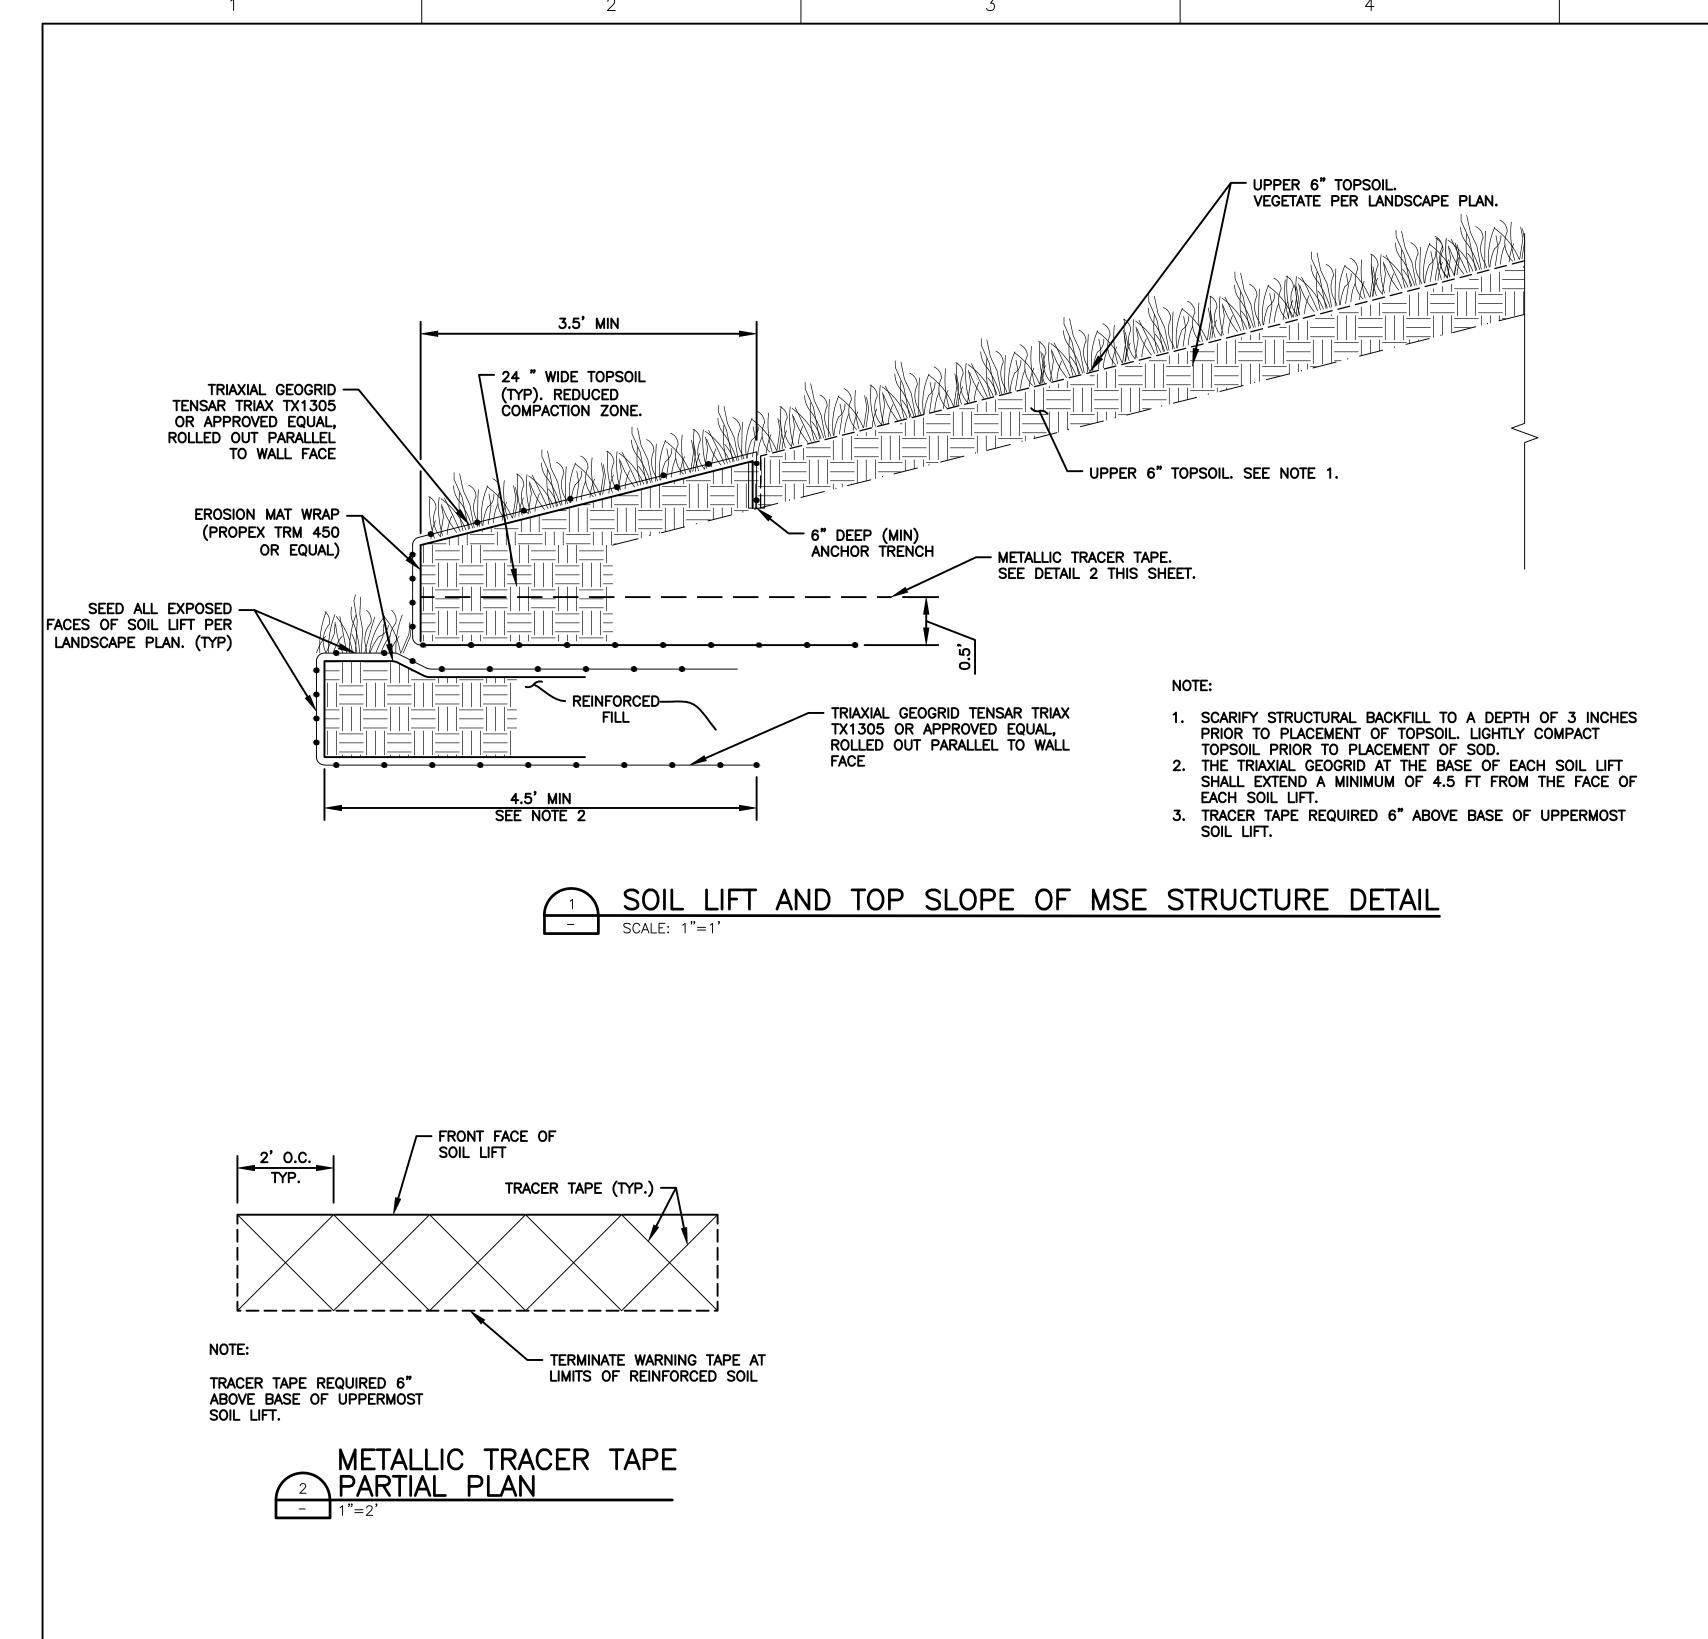

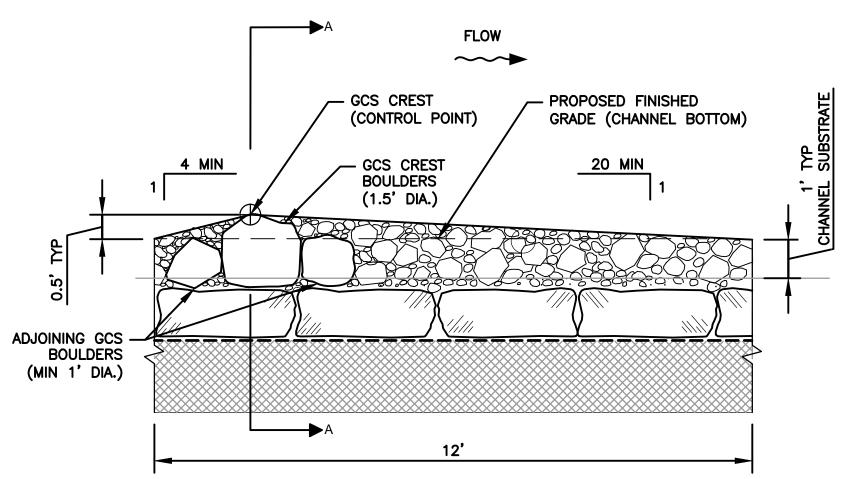

## GRADE CONTROL PROFILE N.T.S.

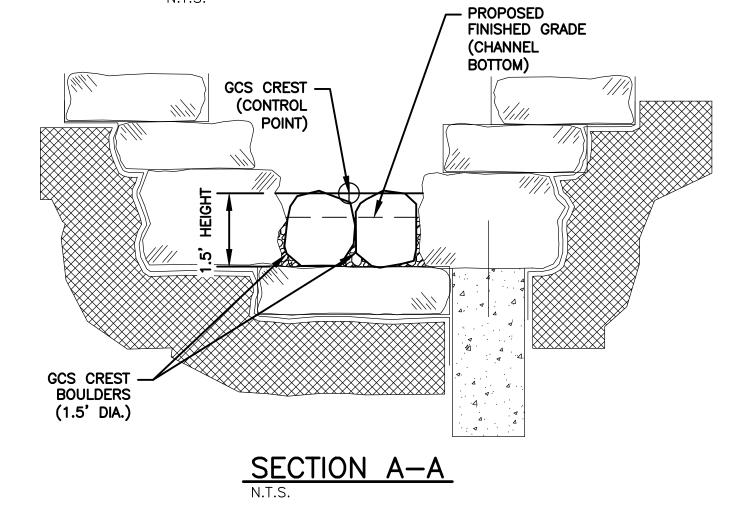

3 GRADE CONTROL STRUCTURE (GCS) DETAIL

HDR En	gineering, Inc.
Firm Re	gistration No. 754
4401 WI	EST GATE BLVD., SUITE 400
<b>AUSTIN</b>	I, TX 78745
PHONE:	# (512) 912-5100
FAV# /F	12) 912-5158

			PROJECT MANAGER	S. MUCHARD
			DESIGNED BY	
			DRAWN BY	C. AMARAL
			CHECKED BY	C. PARKER
A	1-/24/2014	60% DRAFT FOR REVIEW	DATE	JANUARY 2014
ISSUE	DATE	DESCRIPTION	PROJECT NUMBER	220162

THIS DOCUMENT IS RELEASED FOR THE PURPOSE OF REVIEW UNDER THE AUTHORITY OF ERIC J. STEWART TEXAS P.E. NO. 95907 DATE: JANUARY 24, 2014 IT IS NOT TO BE USED FOR CONSTRUCTION OR ANY OTHER PURPOSE. 60% DRAFT



## **ELIZA SPRING OUTLET DAYLIGHTING**

**Austin, Texas** 

MISC. CHANNEL DETAILS

**GRADE CONTROL NOTES:** 

DOWNSTREAM.

CONSTRUCTION.

BOULDERS.

CHANNEL SUBSTRATE.

APPROXIMATELY 4H:1V SLOPE.

1. PLAN: BUILD GRADE CONTROL STRUCTURE (GCS) TO EXTEND ACROSS BASE OF CHANNEL WITH LARGEST

2. PROFILE: CONSTRUCT DOWNSTREAM FACE OF RIFFLE

BOULDERS (MIN 1' DIA.) SHALL ABUT THE DOWNSTREAM AND UPSTREAM FACES OF THE GCS


5. HEIGHT OF EACH GCS SHALL BE 6 INCHES ABOVE PROPOSED FINISHED GRADE OF CHANNEL. 6. GCS CREST BOULDERS SHALL EXTEND AND REST SOUNDLY ON BOULDER LAYER AT BASE OF

3. GCS BOULDERS ARE TO BE PRESELECTED AND PREAPPROVED BY OWNER AND ENGINEER PRIOR

4. THE REPRESENTATIVE DIAMETER OF EACH GCS CREST BOULDER SHALL BE 1.5 FT. ADDITIONAL

AT APPROXIMATELY 20H:1V AND UPSTREAM FACE AT


DIAMETER BOULDERS AT THE CREST LINE AND REDUCE SIZES PROGRESSIVELY UPSTREAM AND

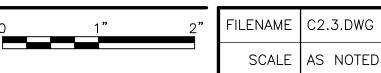



FILENAME | C2.3.DWG


SHEET C2.4


SECTION 0+10 EXISTING GRADE -450 OFF 6.94'-EL 437.52' FINISHED GRADE OFF -6.00'-OFF 5.43' 430 EL 433.47' EL 433.52' OFF -3.00' -└ OFF 3.00' EL 433.47' EL 433.47' 420

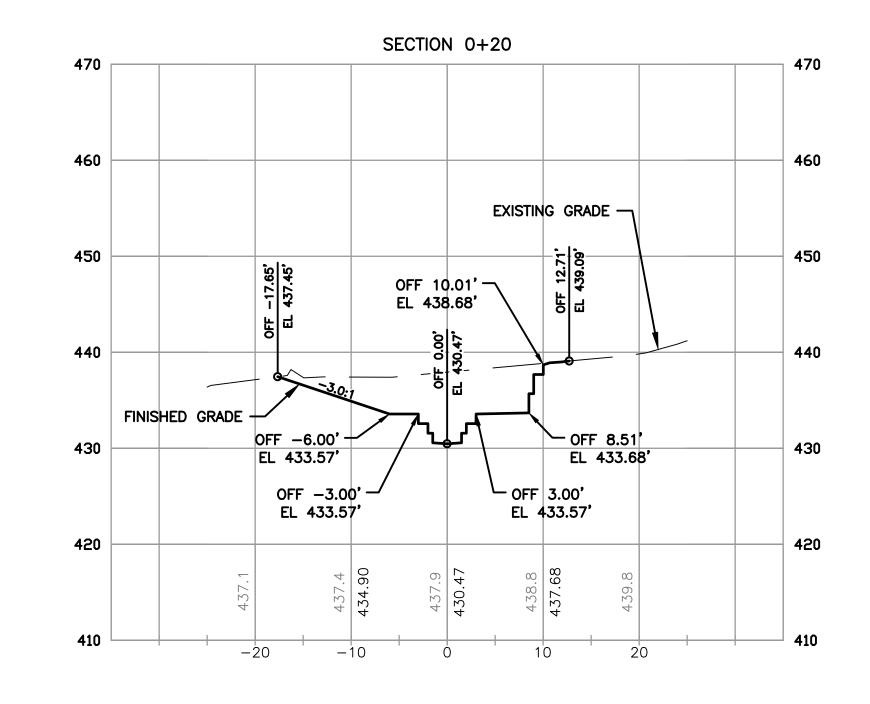

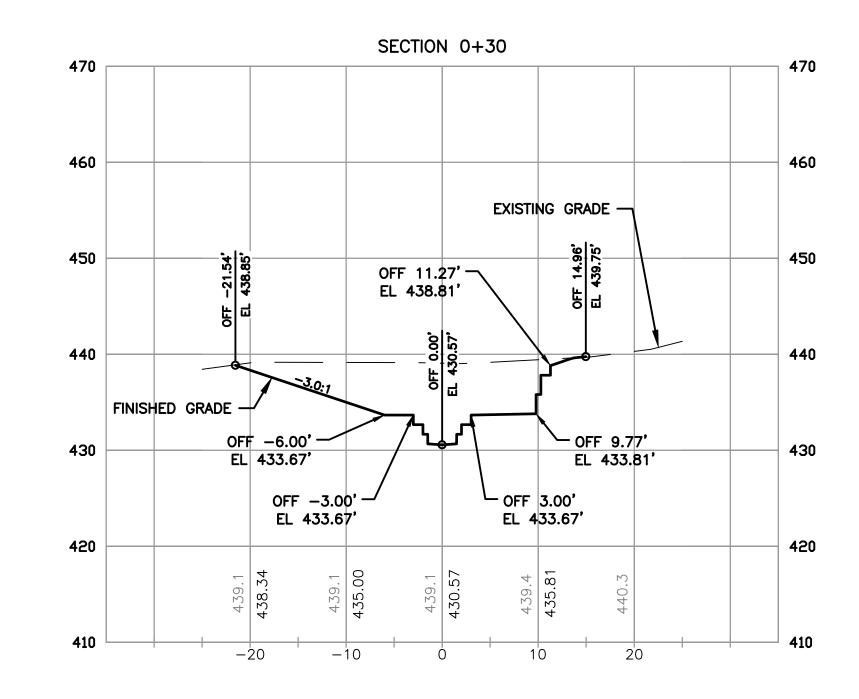

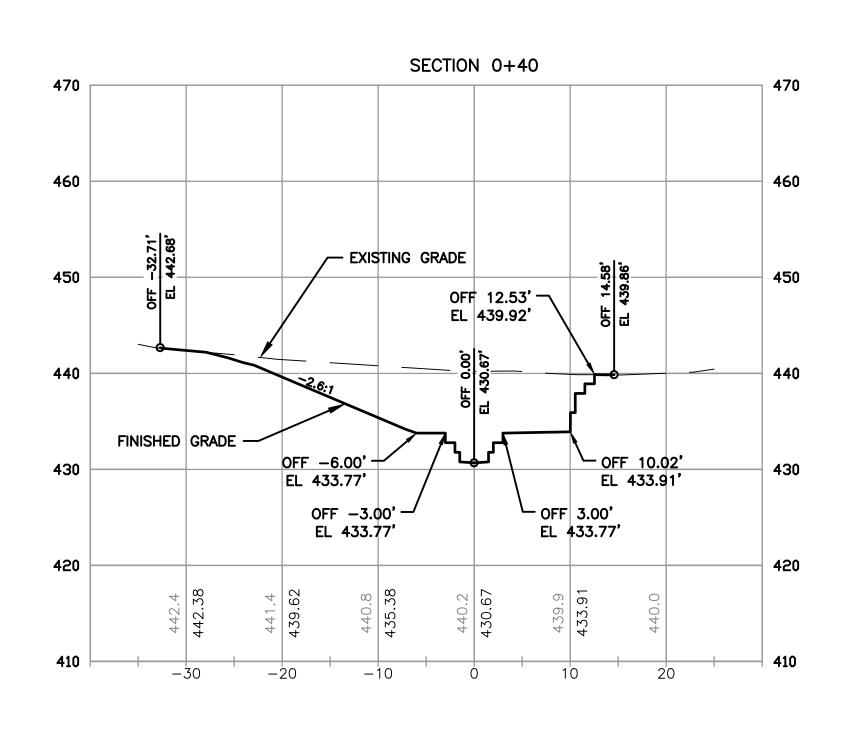

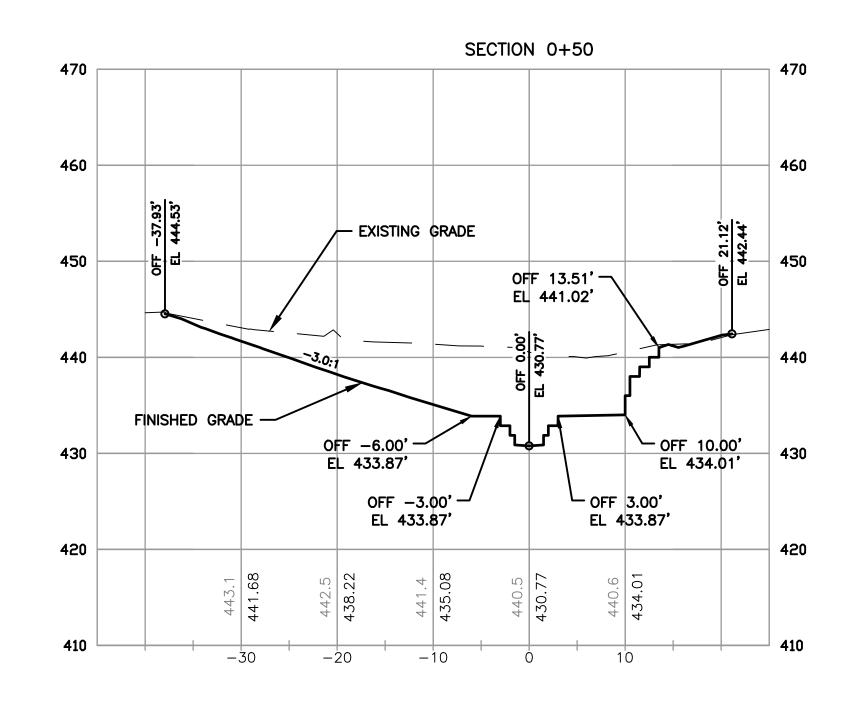

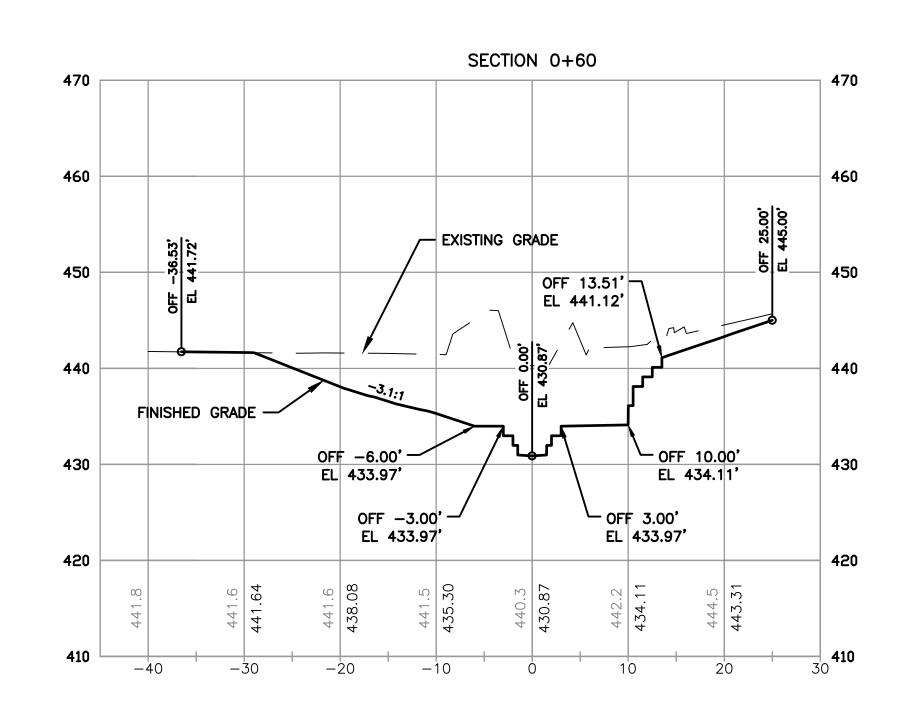



			PROJECT MANAGER	S. MUCHARD
			DESIGNED BY	E. STEWART
			DRAWN BY	C. AMARAL
			CHECKED BY	C. PARKER
7	1-/24/2014	60% DRAFT FOR REVIEW	DATE	JANUARY 2014
UE	DATE	DESCRIPTION	PROJECT NUMBER	220162

THIS DOCUMENT IS RELEASED FOR THE PURPOSE OF REVIEW UNDER THE AUTHORITY OF ERIC J. STEWART TEXAS P.E. NO. 95907 DATE: JANUARY 24, 2014 IT IS NOT TO BE USED FOR CONSTRUCTION OR ANY OTHER PURPOSE.



ELIZA SPRING OUTLET DAYLIGHTING

Austin, Texas


**CROSS SECTIONS** 


1" 2" FIL

FILENAME C2.5.DWG

SCALE 1" = 10'

C2.5

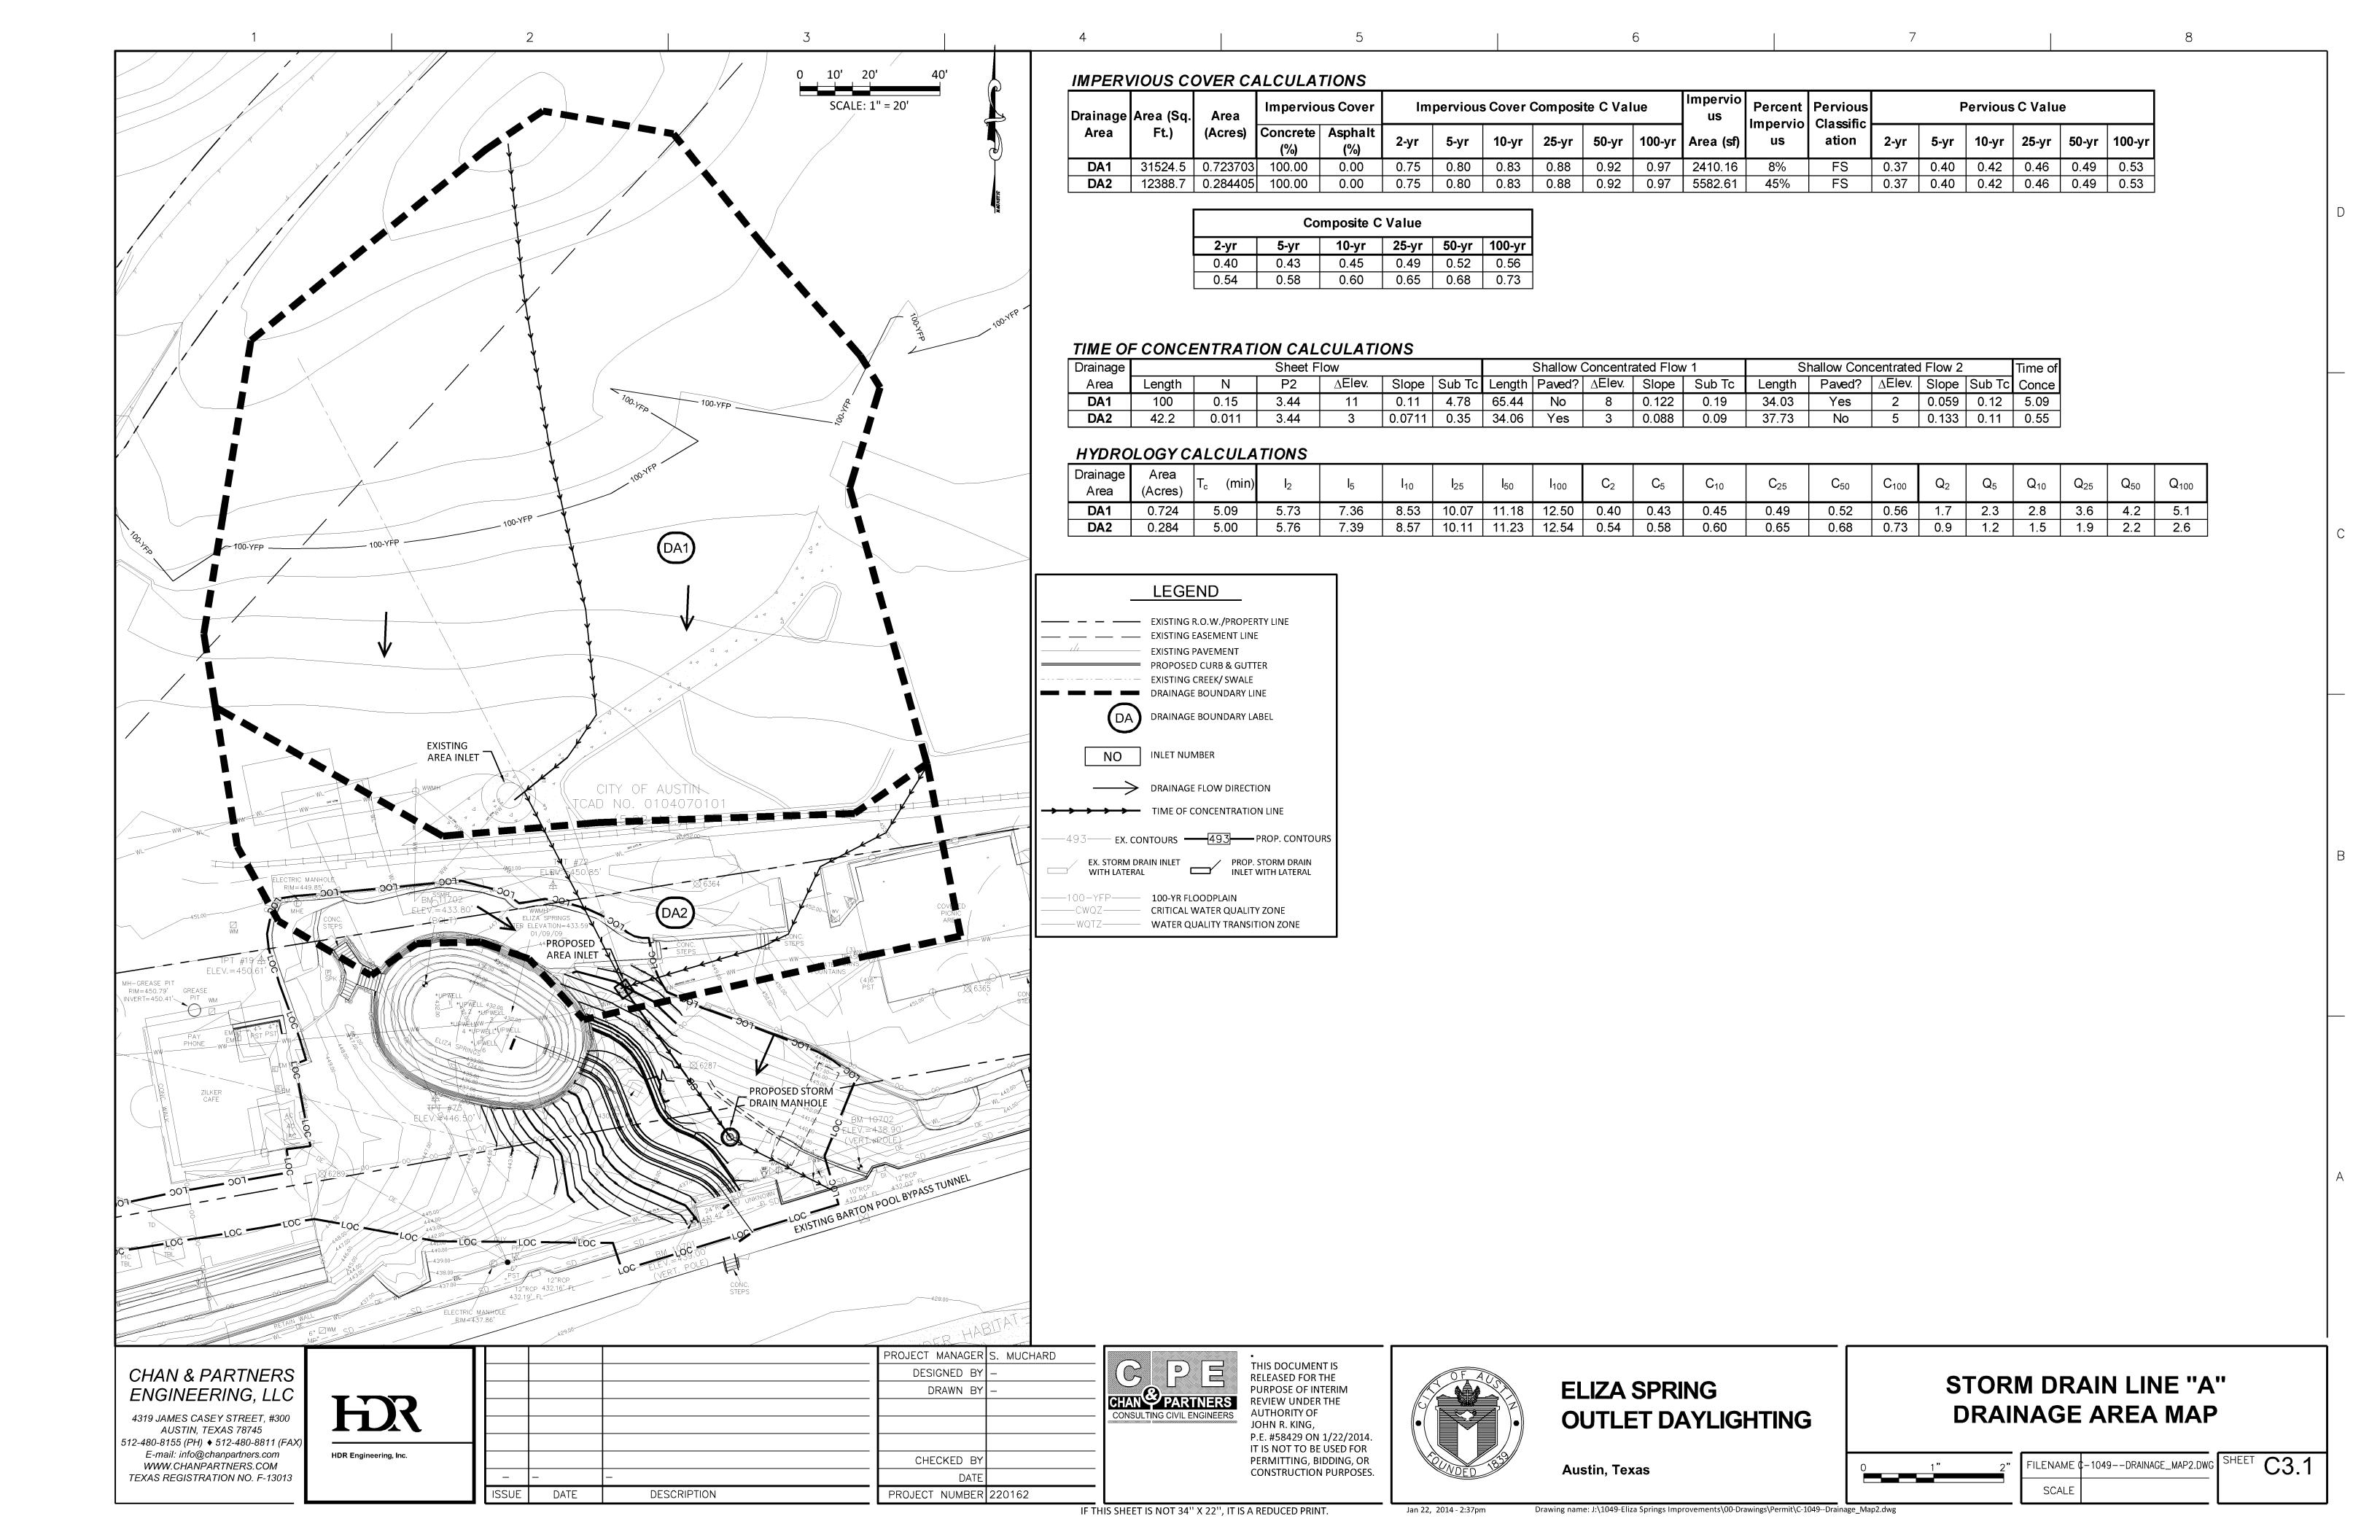

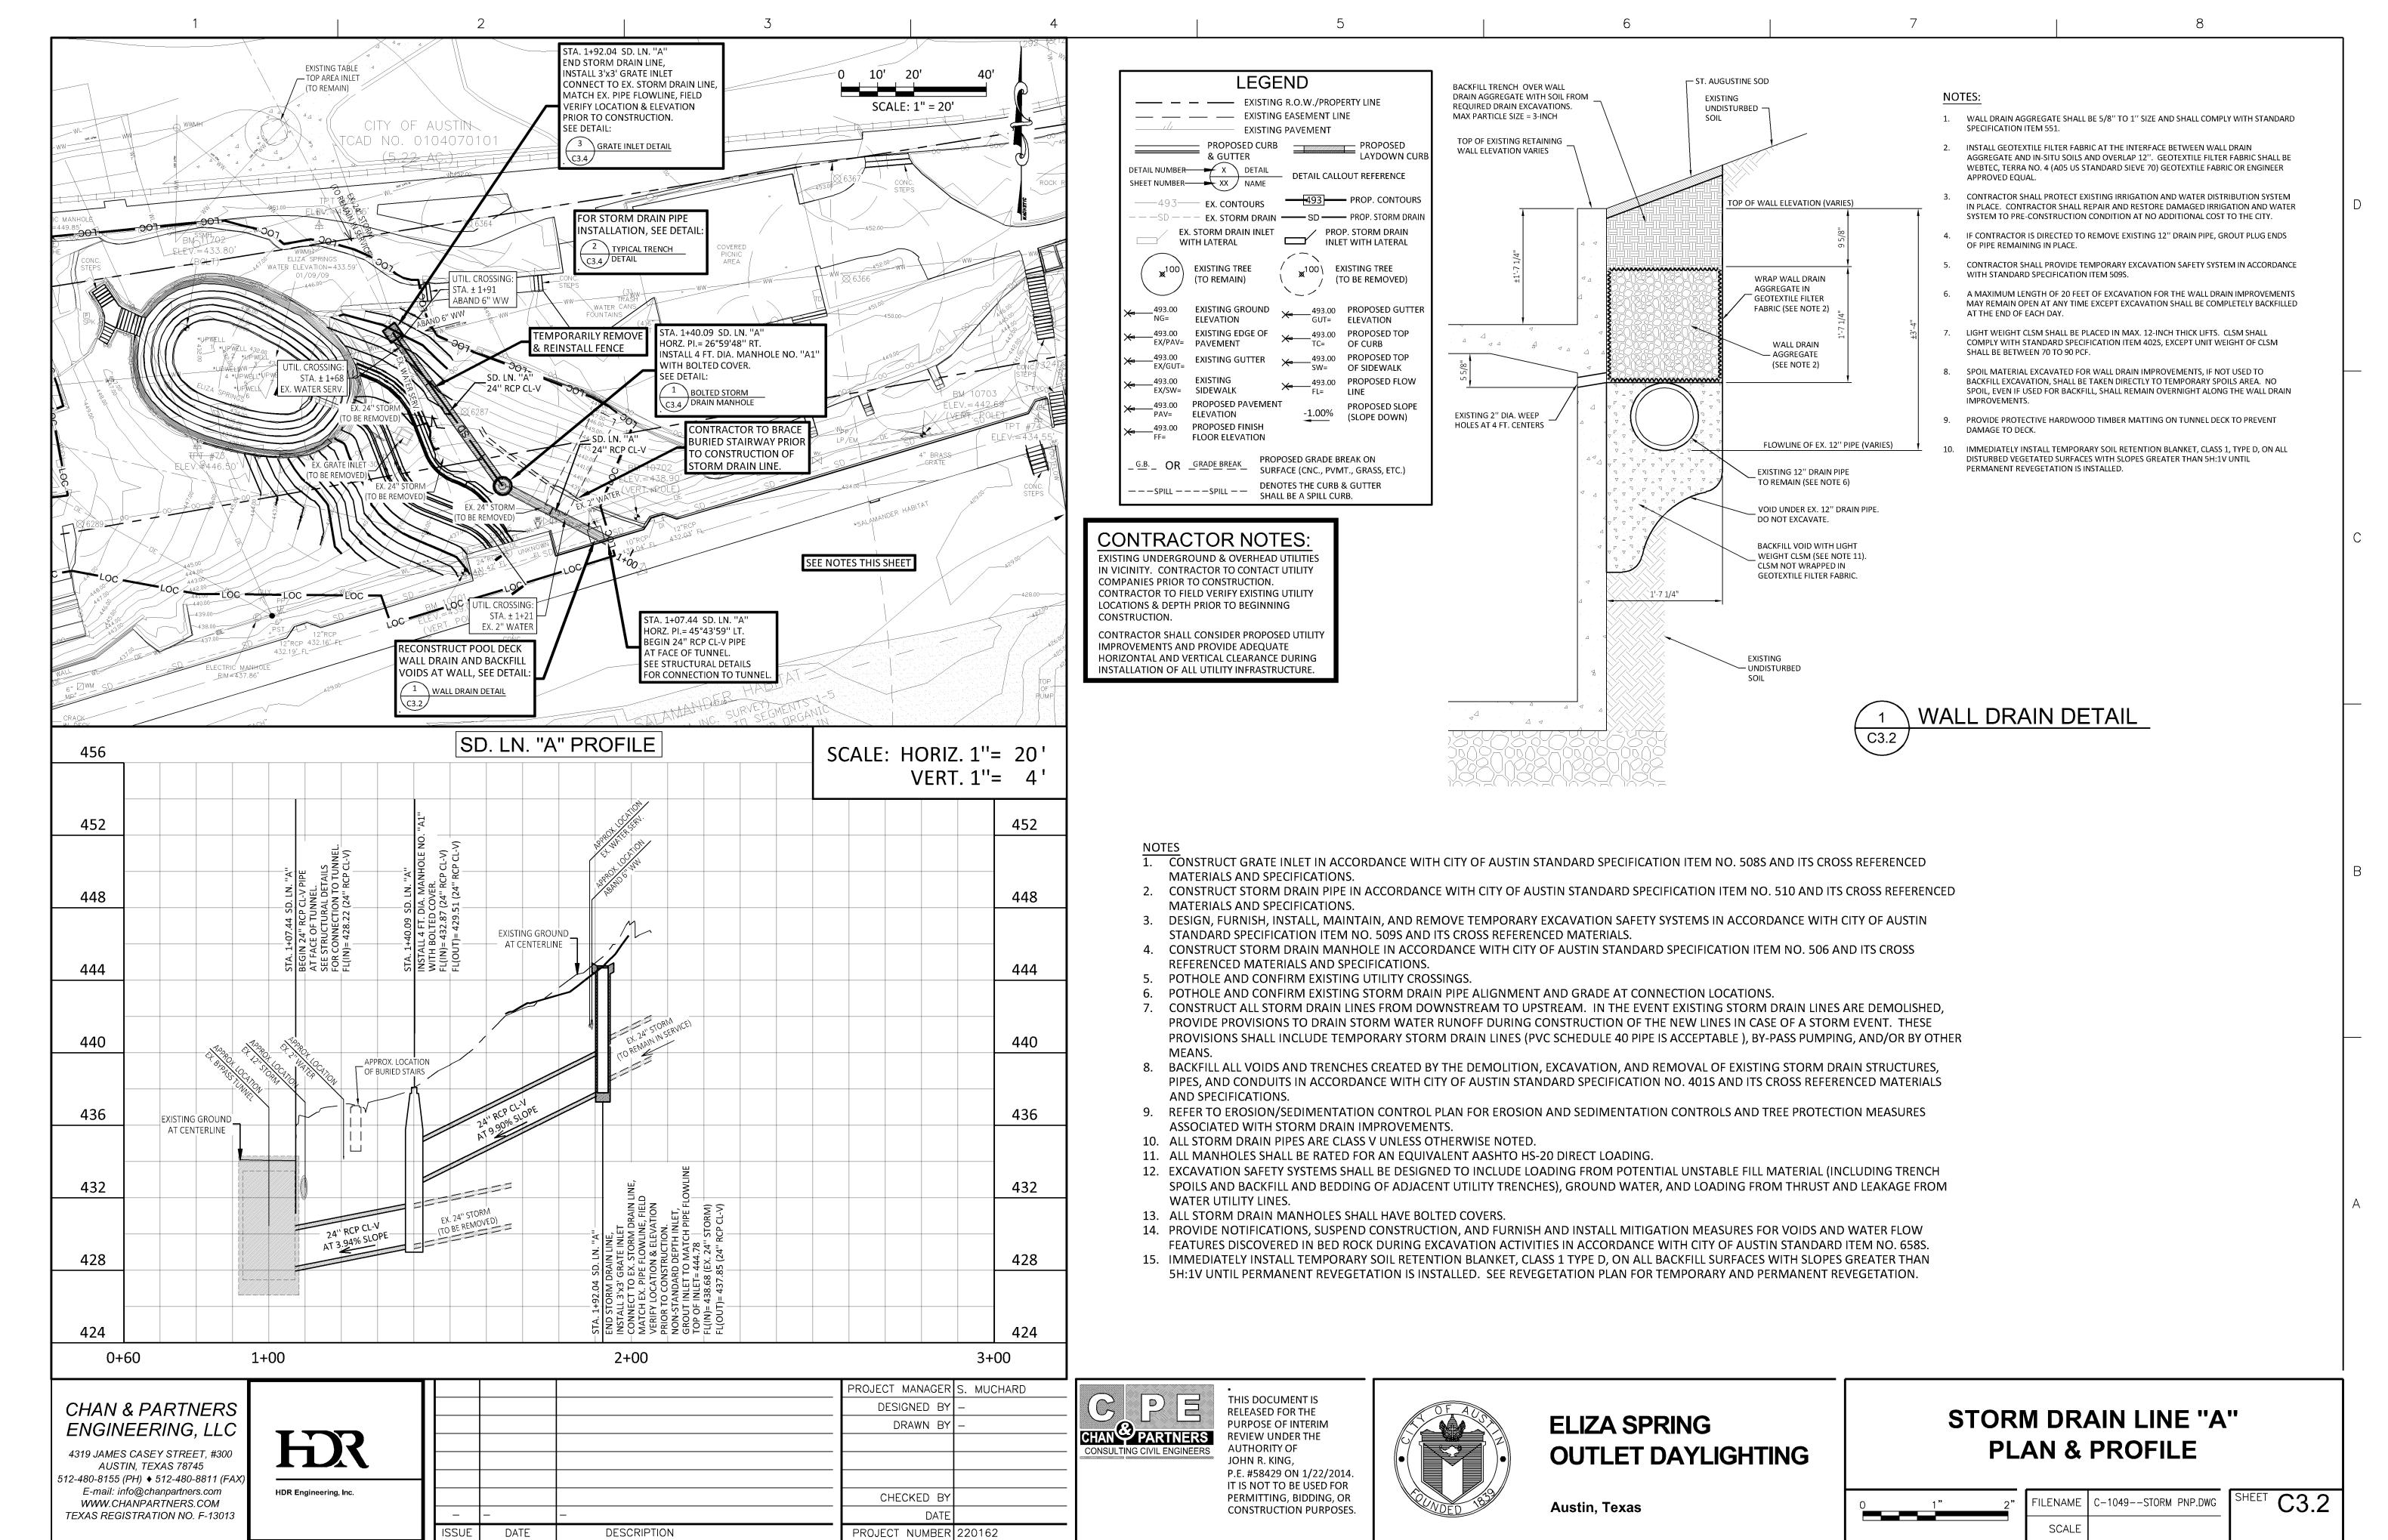

IF THIS SHEET IS NOT 34" X 22", IT IS A REDUCED PRINT.

Jan 22, 2014 - 2:38pm

Drawing name: J:\1049-Eliza Springs Improvements\00-Drawings\Permit\C-1049--STORM PNP.dwg

